


LES FALLS
A CONDOMINIUM

Architect Engineering

Project No.	11111
Client	ABC Corp.
Date	11/11/84
Scale	1/4" = 1'-0"
Sheet No.	11111-01

LOK

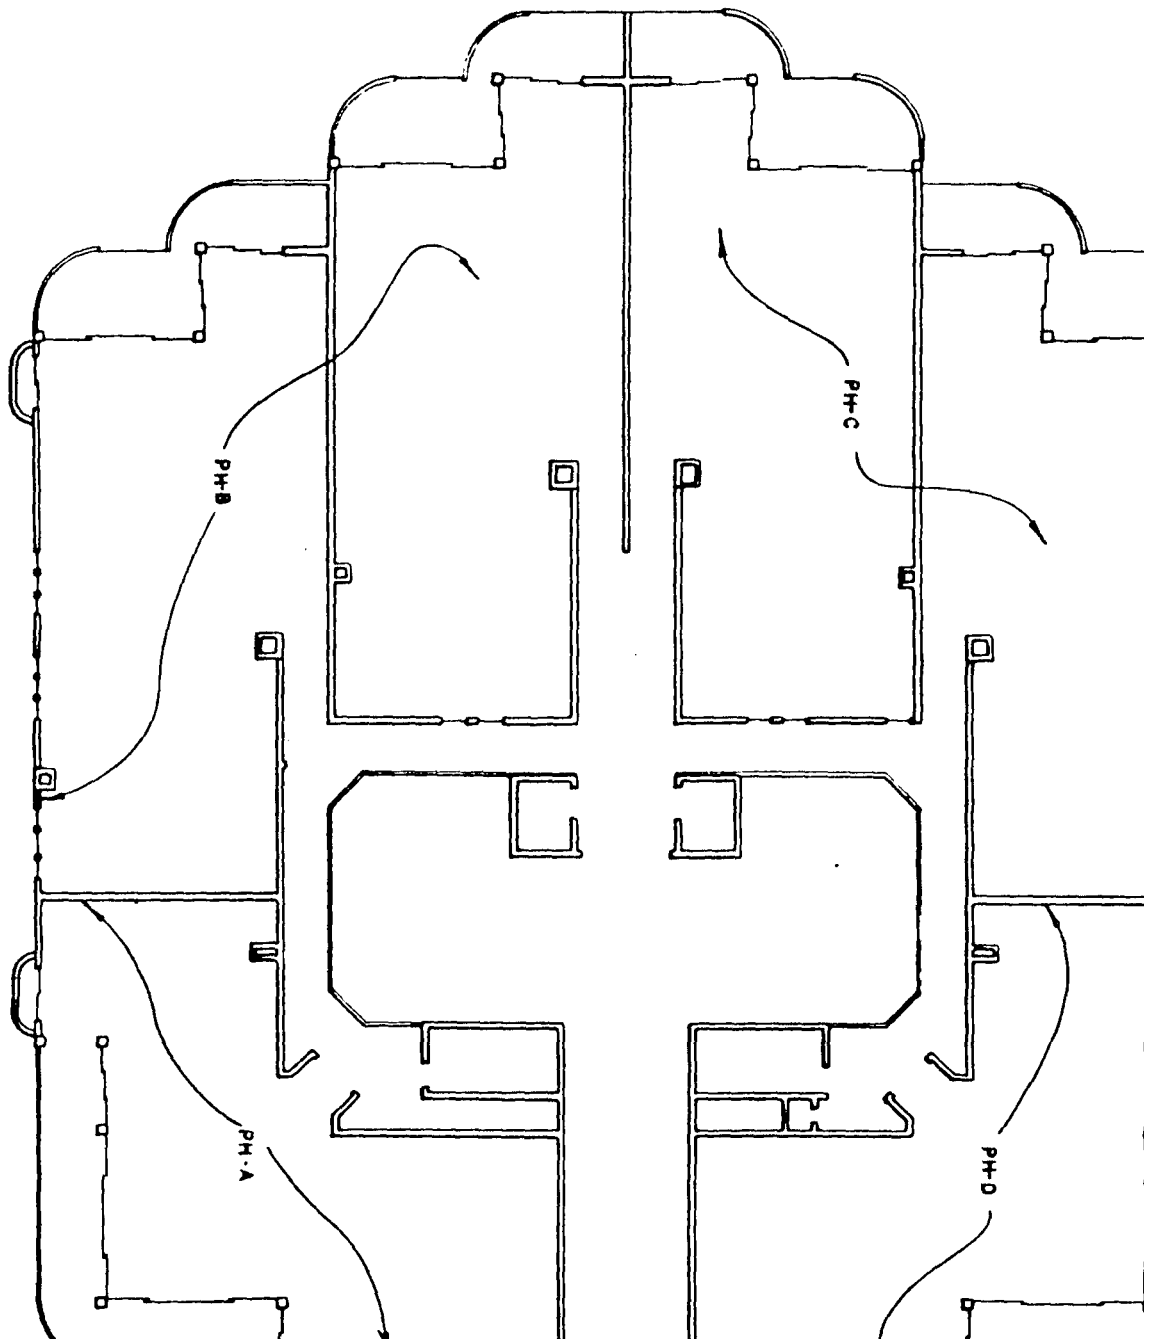





LES FALLS


Architect Engineering
100 West Long Street, Suite 1110
Cincinnati, Ohio 45202
Tel: 513-241-1100
Fax: 513-241-1101
www.lesfalls.com

FL

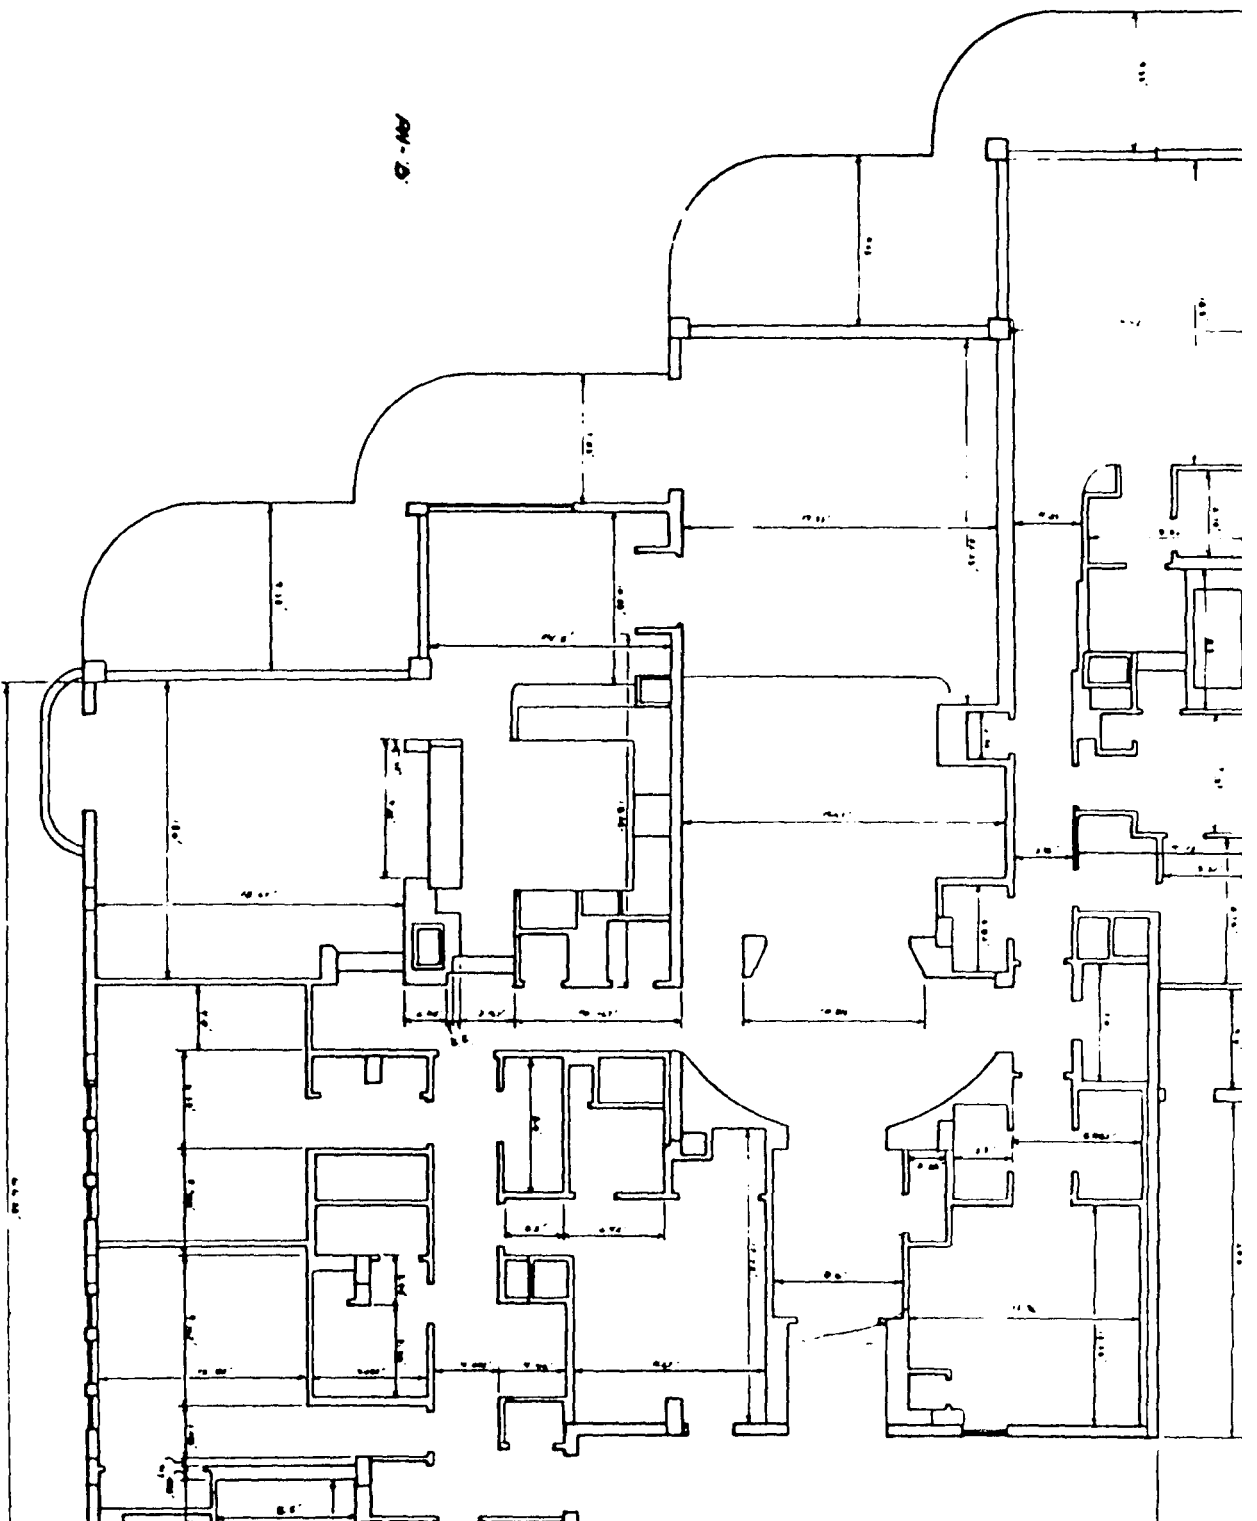

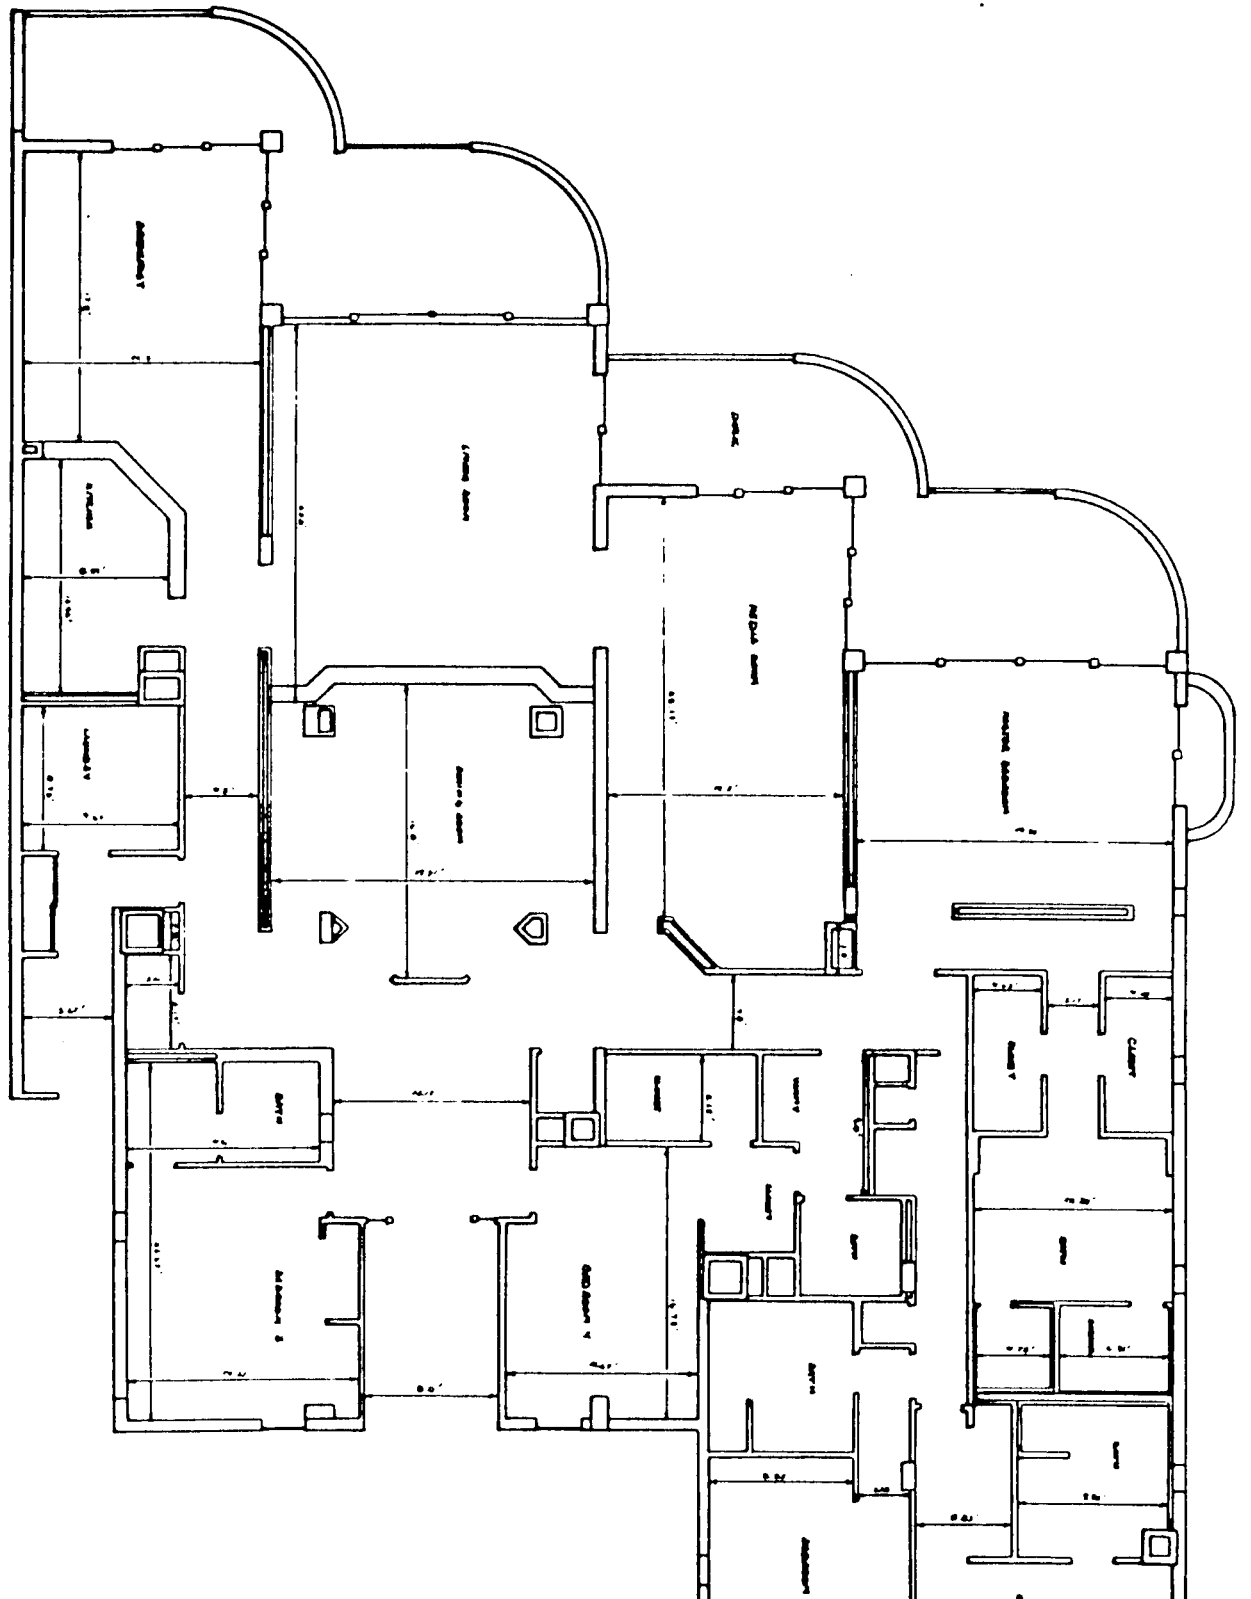


GULF OF MEXICO

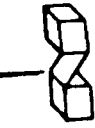

SCALE: 1" = 20'

ROOM	ELEVATIONS	UNIT NUMBERS
	FLOOR	CEILING
101	10.00	10.00
102	10.00	10.00
103	10.00	10.00
185	10.00	10.00
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187	10.00	10.00
188	10.00	10.00
189	10.00	10.00
190	10.00	10.00
191	10.00	10.00
192	10.00	10.00
193	10.00	10.00
194	10.00	10.00
195	10.00	10.00
196	10.00	10.00
197	10.00	10.00
198	10.00	10.00
199	10.00	10.00
200	10.00	10.00

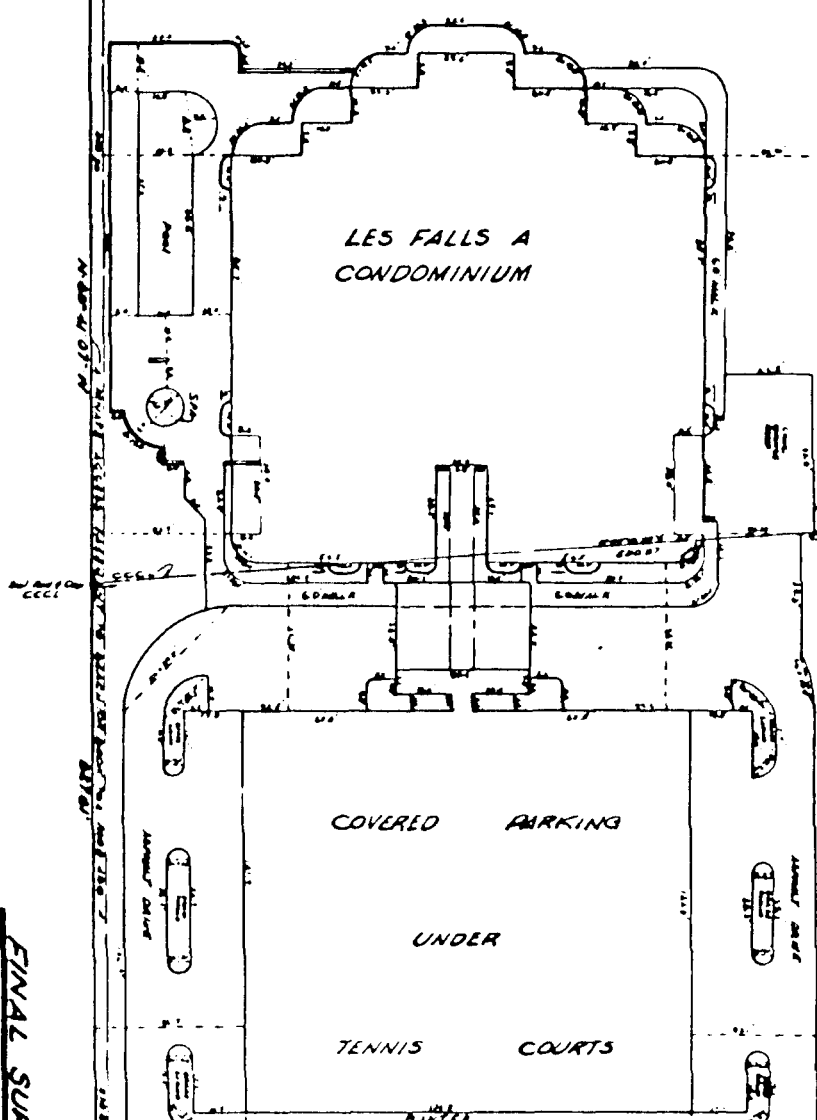

LES FALLS A CONDOMINIUM
 UNIT NUMBERS
 101-200

SCALE: 1" = 20'



DESCRIPTION
 This is a site plan of the LES FALLS A CONDOMINIUM, located at the intersection of the Gulf of Mexico and the Gulf of Mexico. The plan shows the building layout, including the main building, a covered parking area, and tennis courts. The building is situated on a lot bounded by the Gulf of Mexico to the north and east, and the Gulf of Mexico to the south and west. The plan also shows the location of the building's entrance, parking spaces, and tennis courts. The building is a multi-story structure with a central core and several wings. The covered parking area is located to the south of the building, and the tennis courts are located to the west of the building. The plan is drawn to a scale of 1 inch = 20 feet.


FINAL SURVEY
LES FALLS A CONDOMINIUM

LES FALLS
A CONDOMINIUM



GROUND

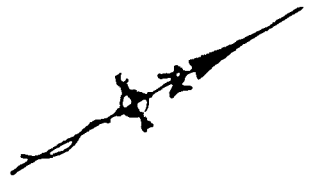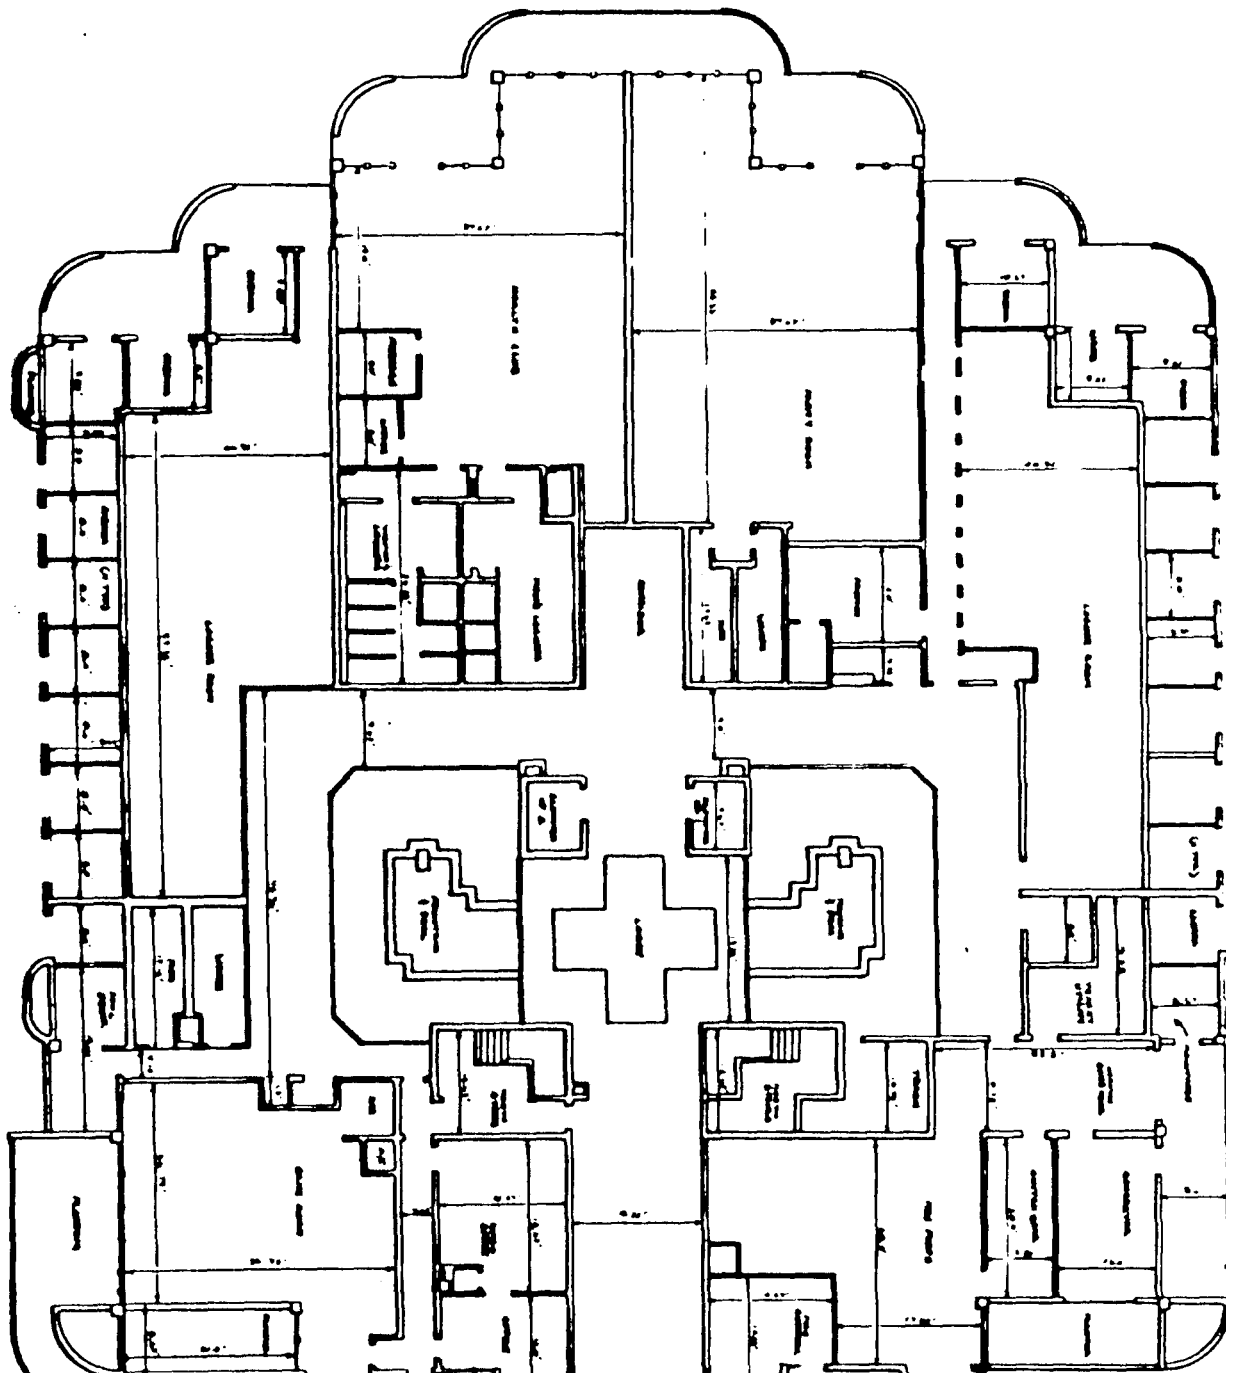

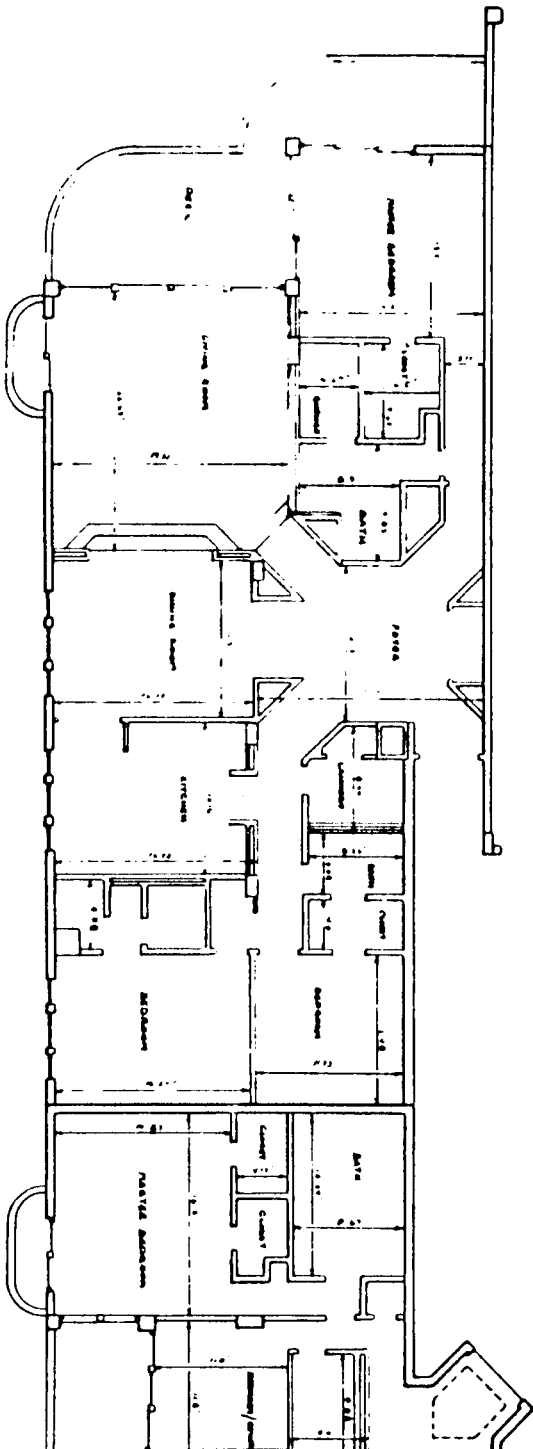

TYPICAL UNIT
101-101-101-101-101-101
101

TYPICAL UNIT
101-101-101-101-101-101
101

LES FALLS
A CONDOMINIUM

Anchor Engineering




1111 South Main Street, Suite 100, Portland, OR 97204
503.255.1111
www.anchor-engineering.com

PROJECT NO. 101-101-101-101-101-101
DATE 10/10/10


SCALE 1/8" = 1'-0"

LES FALLS A CONDOMINIUM

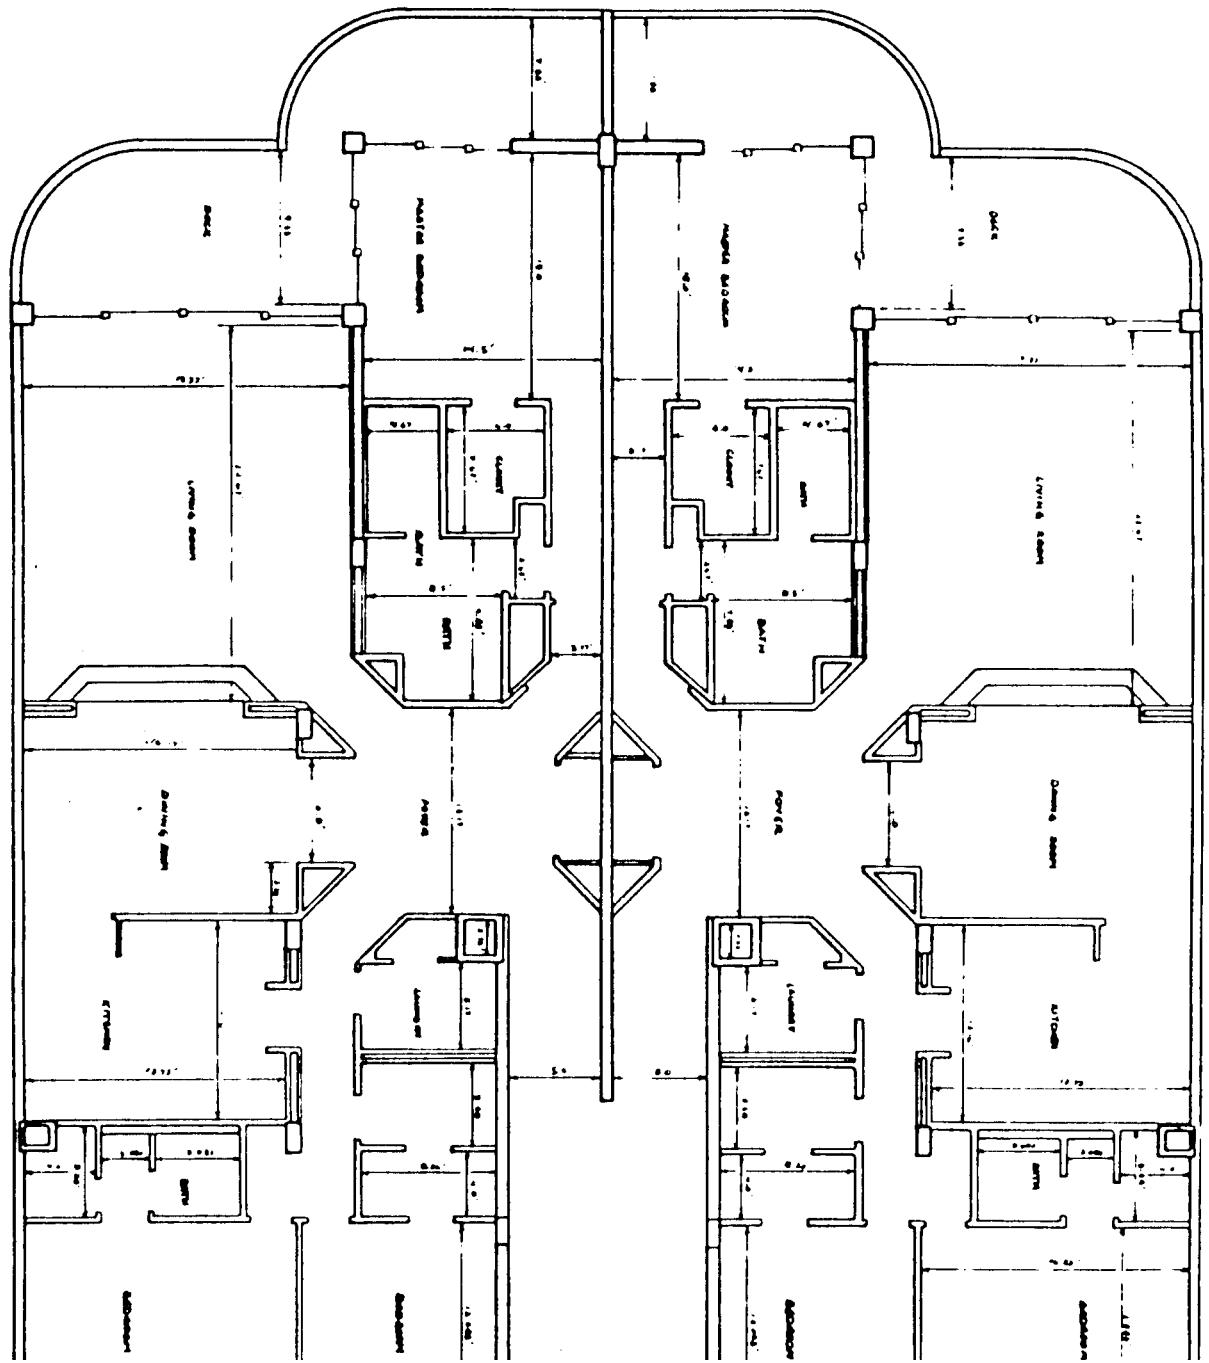

Architect Engineering

1234 Main Street, Suite 100, New York, NY 10001

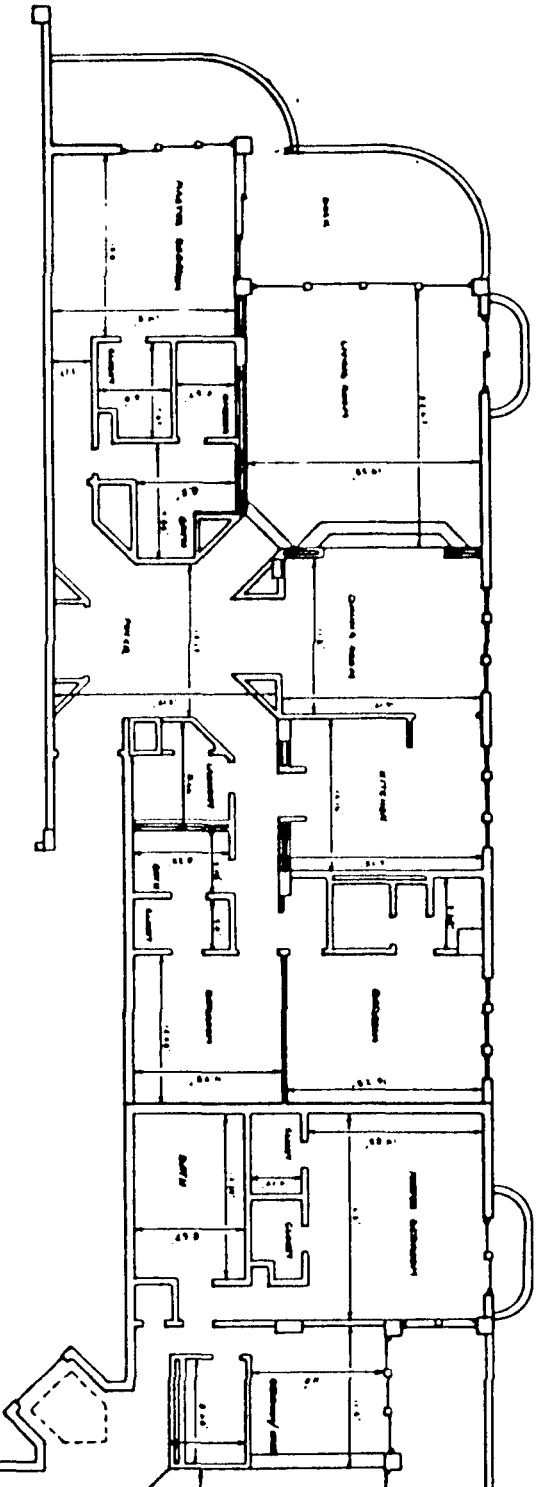

TYPICAL UNITS
 103-208, 103-209, 209
 940-728


LES FALLS
 A CONDOMINIUM

Architect: Engineering

12345 Main St., Suite 100
 City, State, Zip

DATE	BY	REVISION
10/1/88	J.S.	1.0
11/1/88	J.S.	2.0
12/1/88	J.S.	3.0
01/01/89	J.S.	4.0
02/01/89	J.S.	5.0
03/01/89	J.S.	6.0
04/01/89	J.S.	7.0
05/01/89	J.S.	8.0
06/01/89	J.S.	9.0
07/01/89	J.S.	10.0
08/01/89	J.S.	11.0
09/01/89	J.S.	12.0


FLC

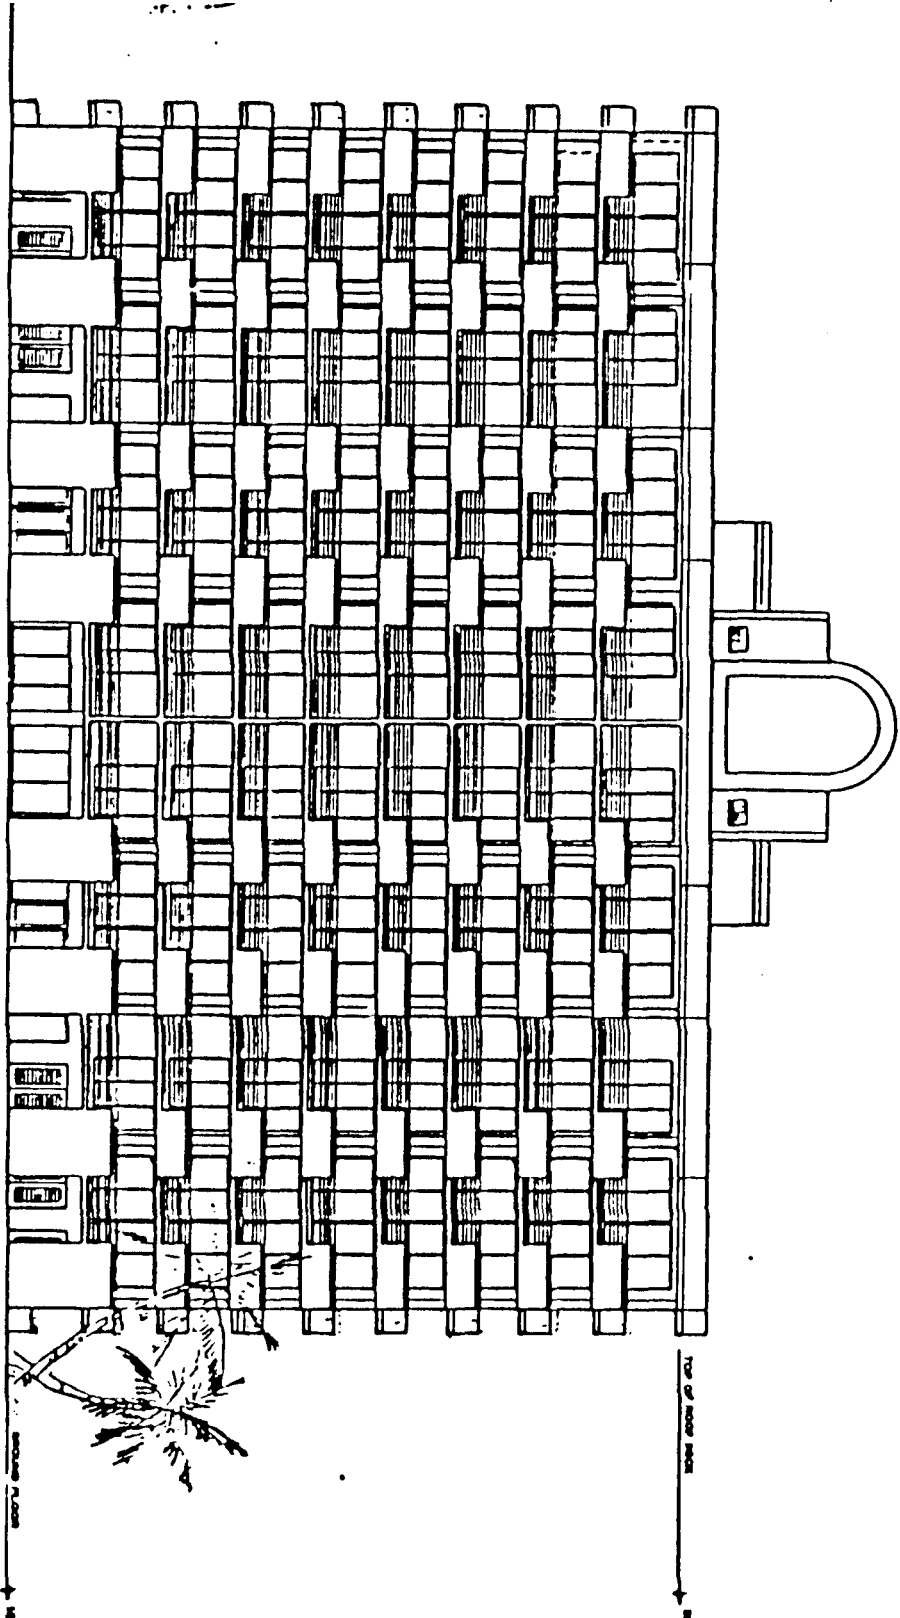

WEST ELEVATION


1/2" = 1'-0"

SOUTH ELEVATION

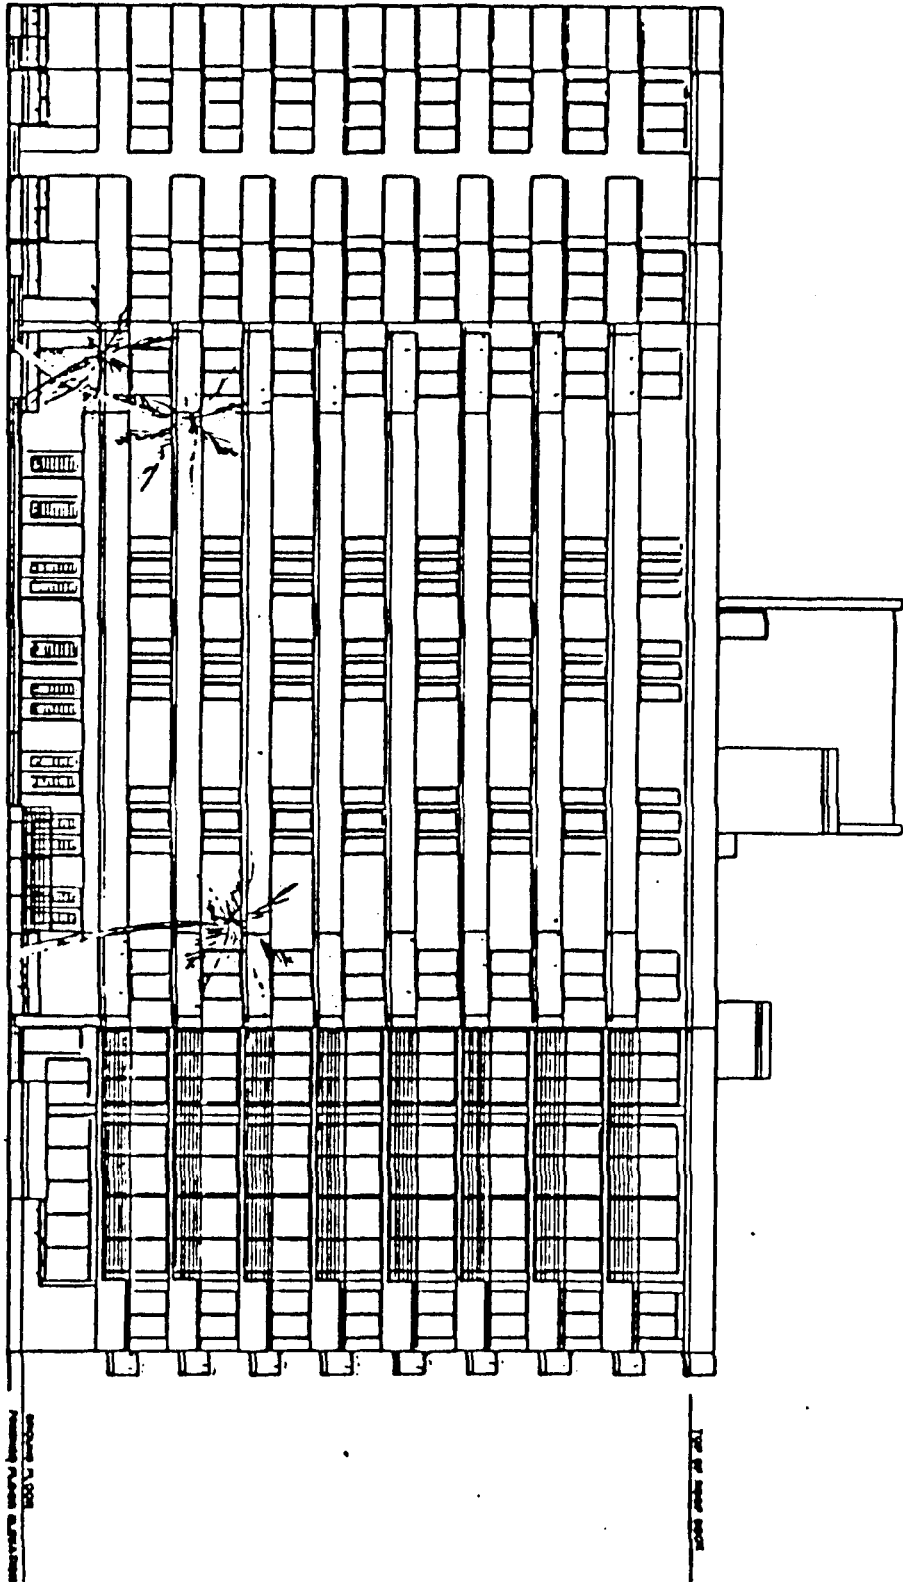

100' 0" SCALE

TOP OF MAIN FLOOR

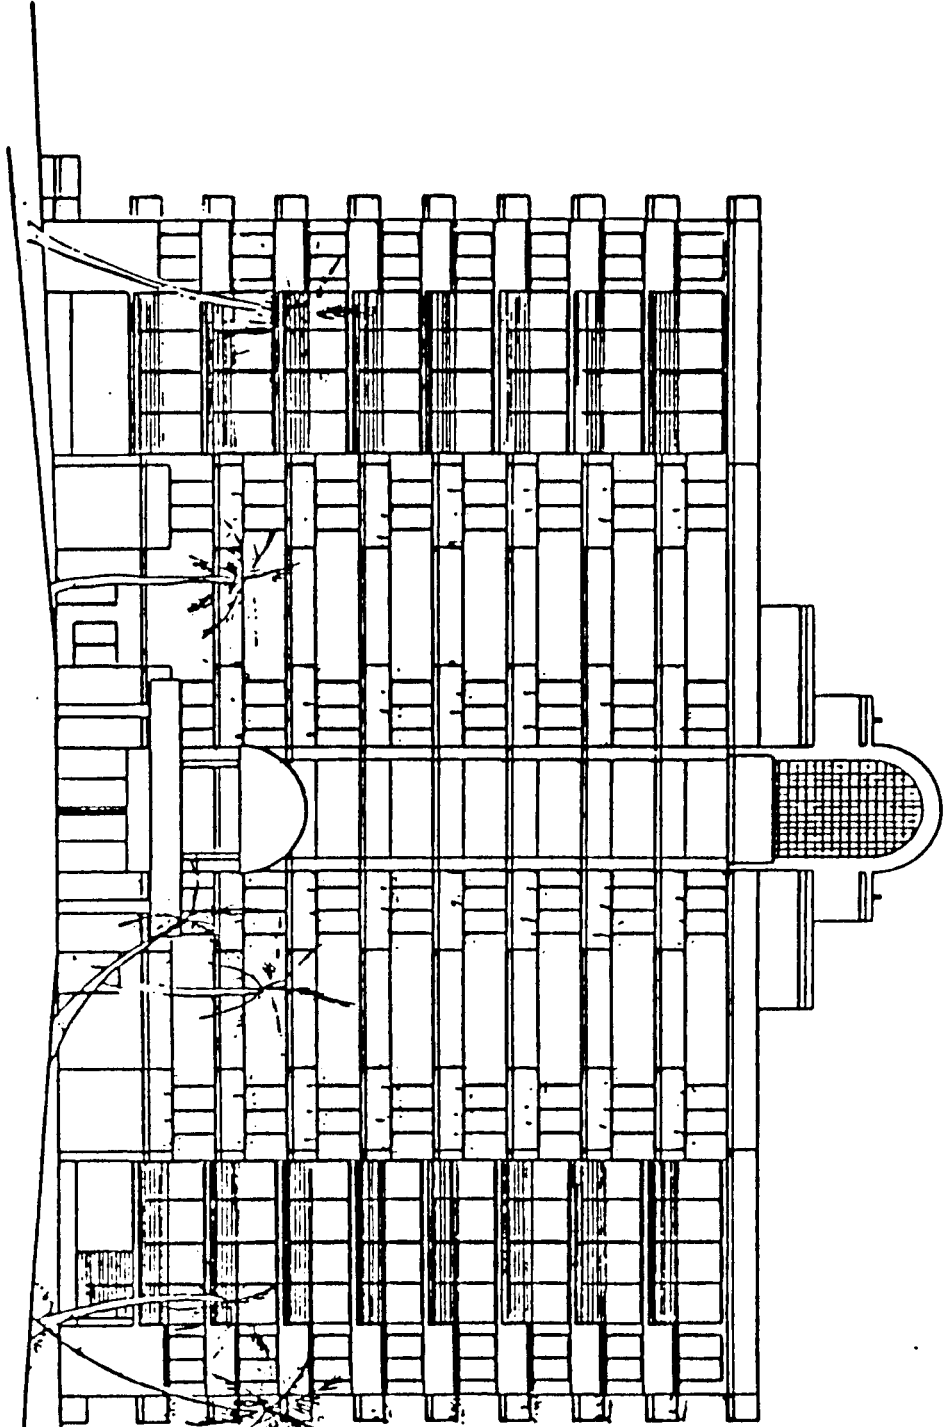

EAST ELEVATION

GROUND FLOOR
FIRST FLOOR ELEVATION



TOP OF ROOF FINISH ELEVATION
TOP OF ROOF FINISH


1st

1st

PENTHOUSE PLAN


TOTAL AREA
BY ROOM

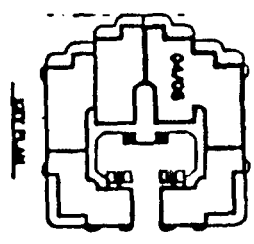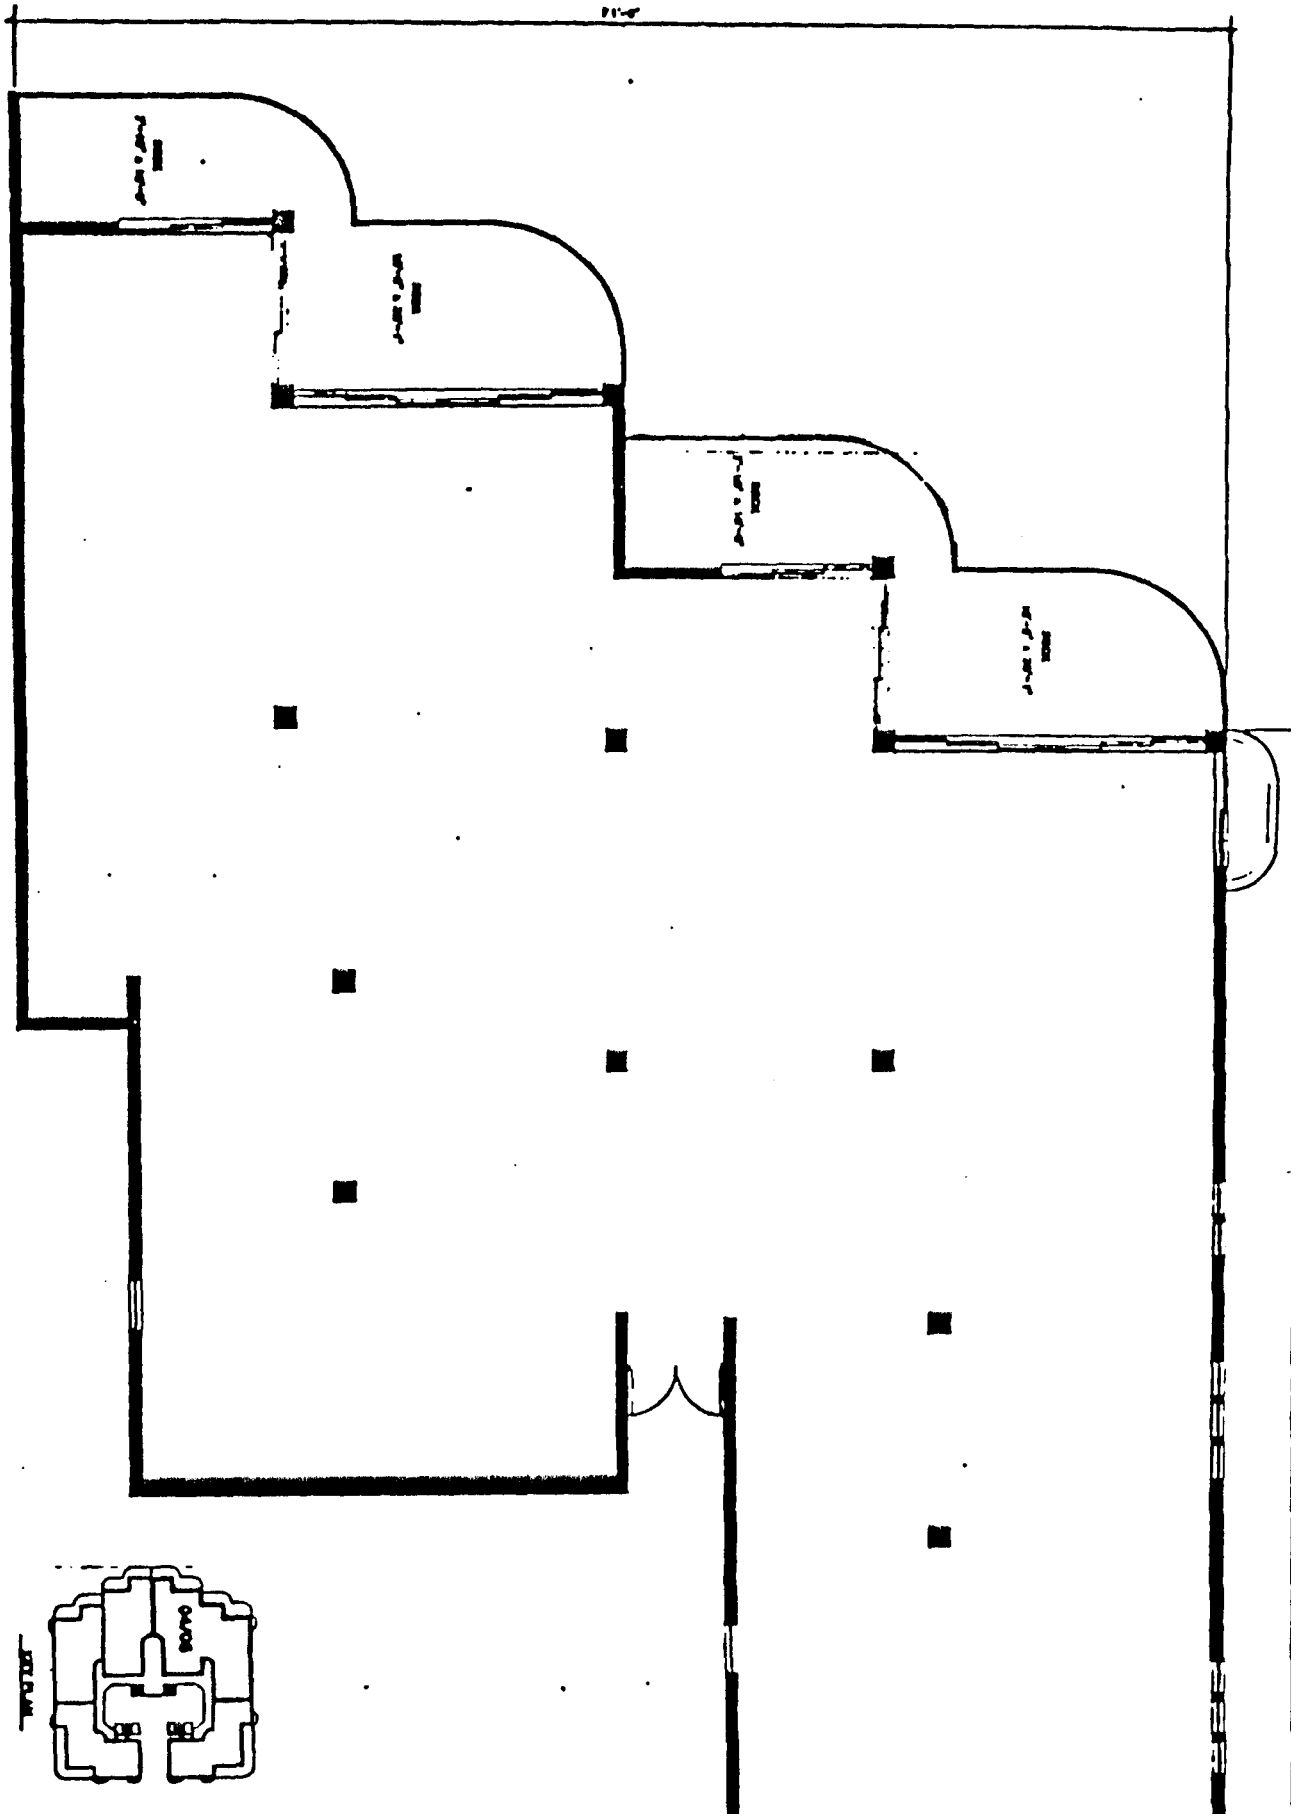

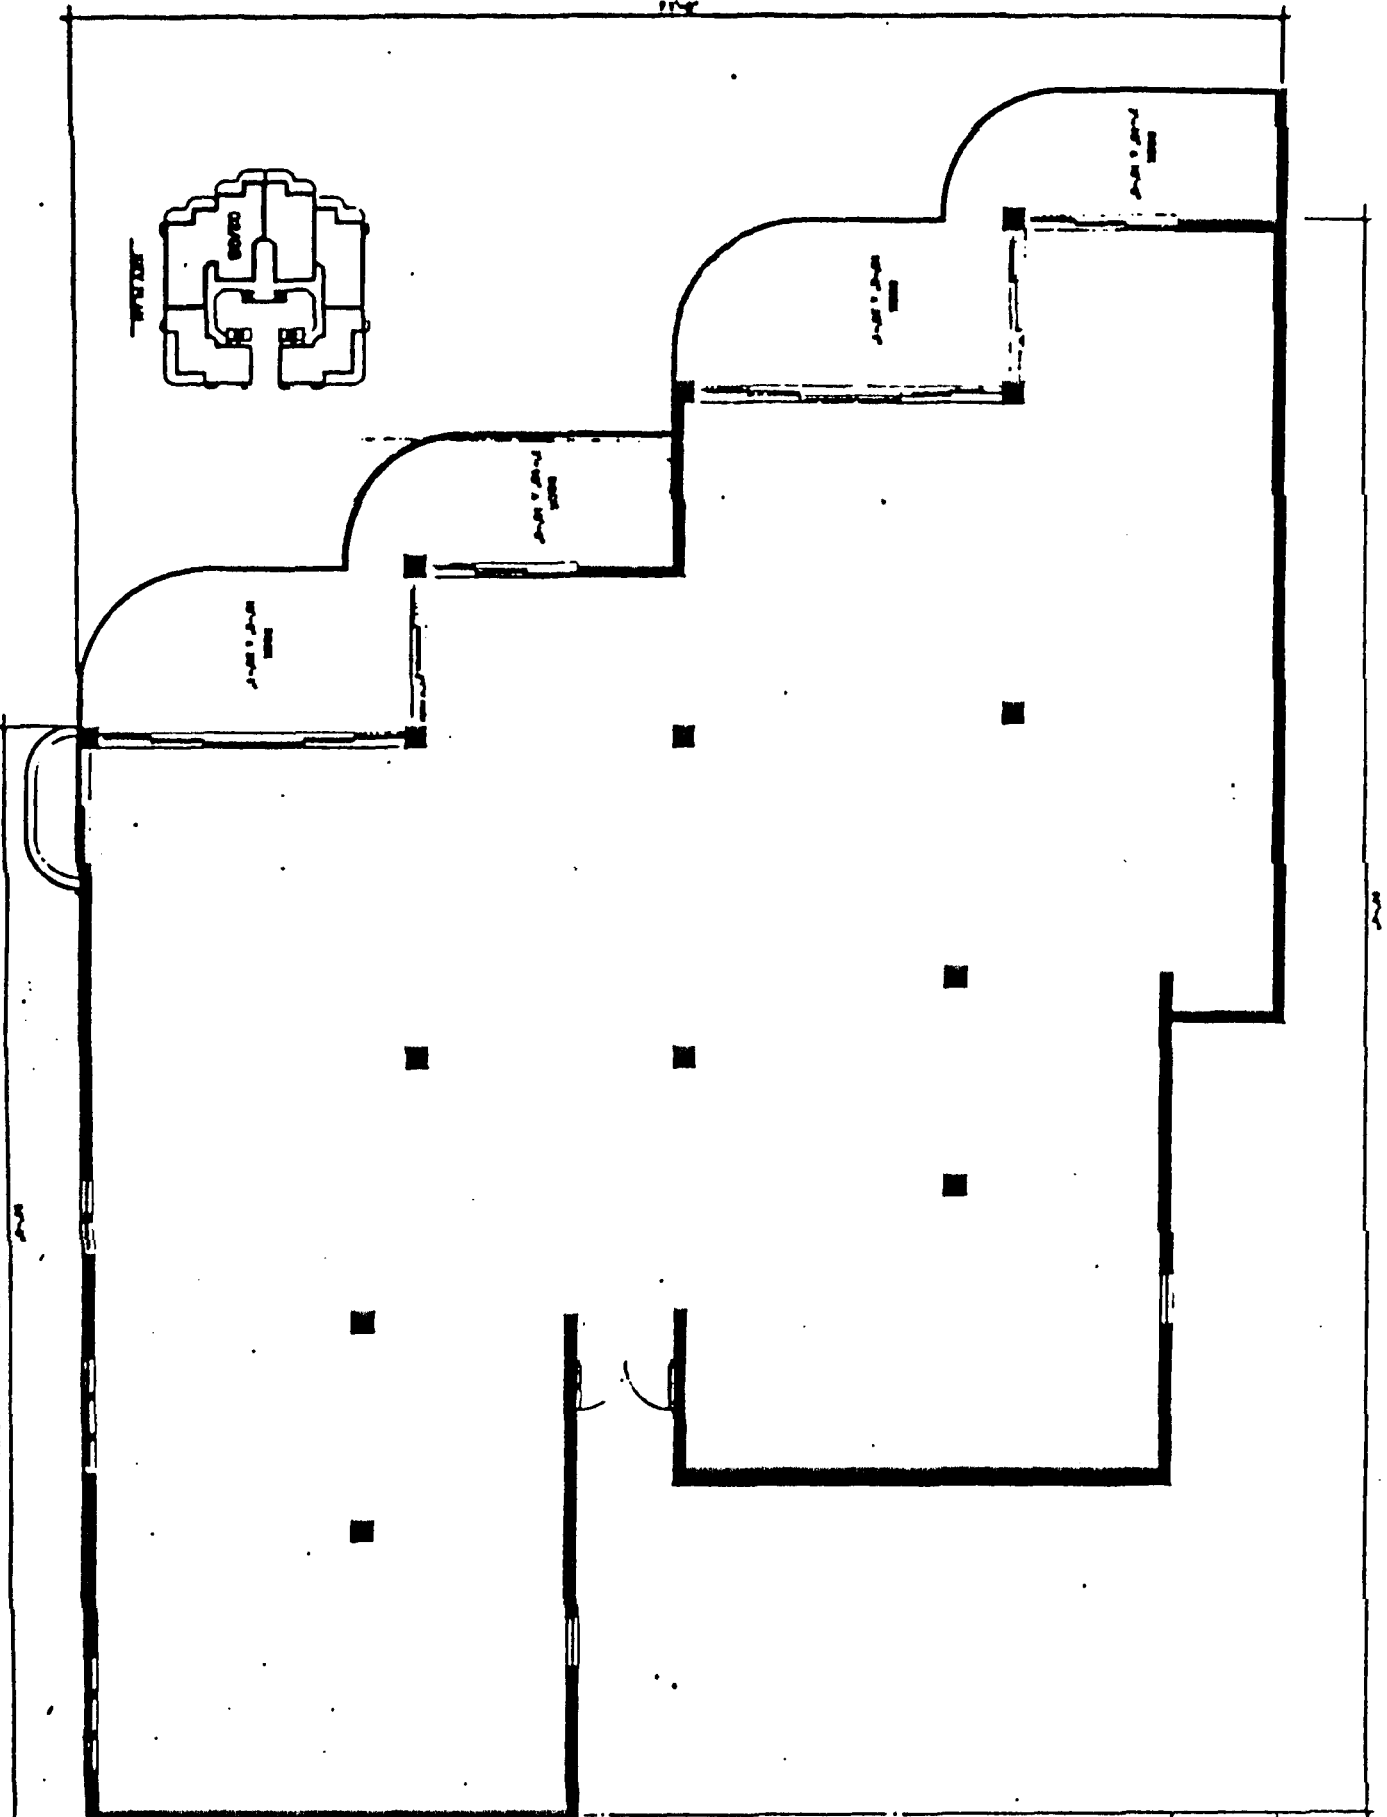

PENTHOUSE PLAN


Scale: 1/4" = 1'-0"

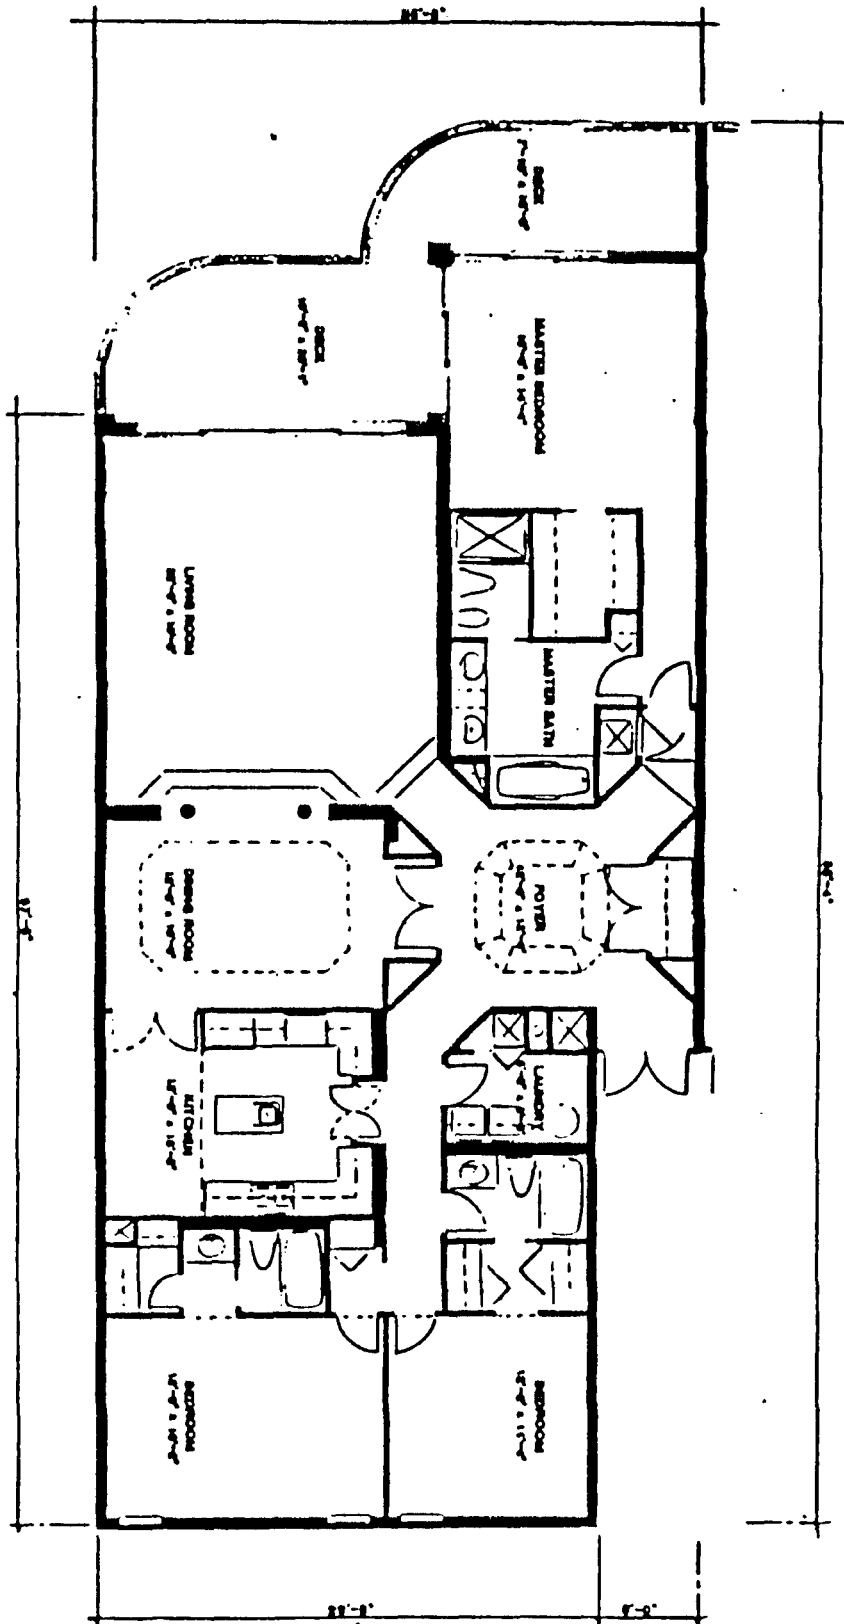


TYPICAL UNIT PLAN





TOTAL GROSS
SFT 1,411

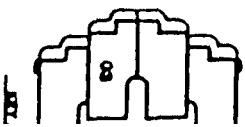

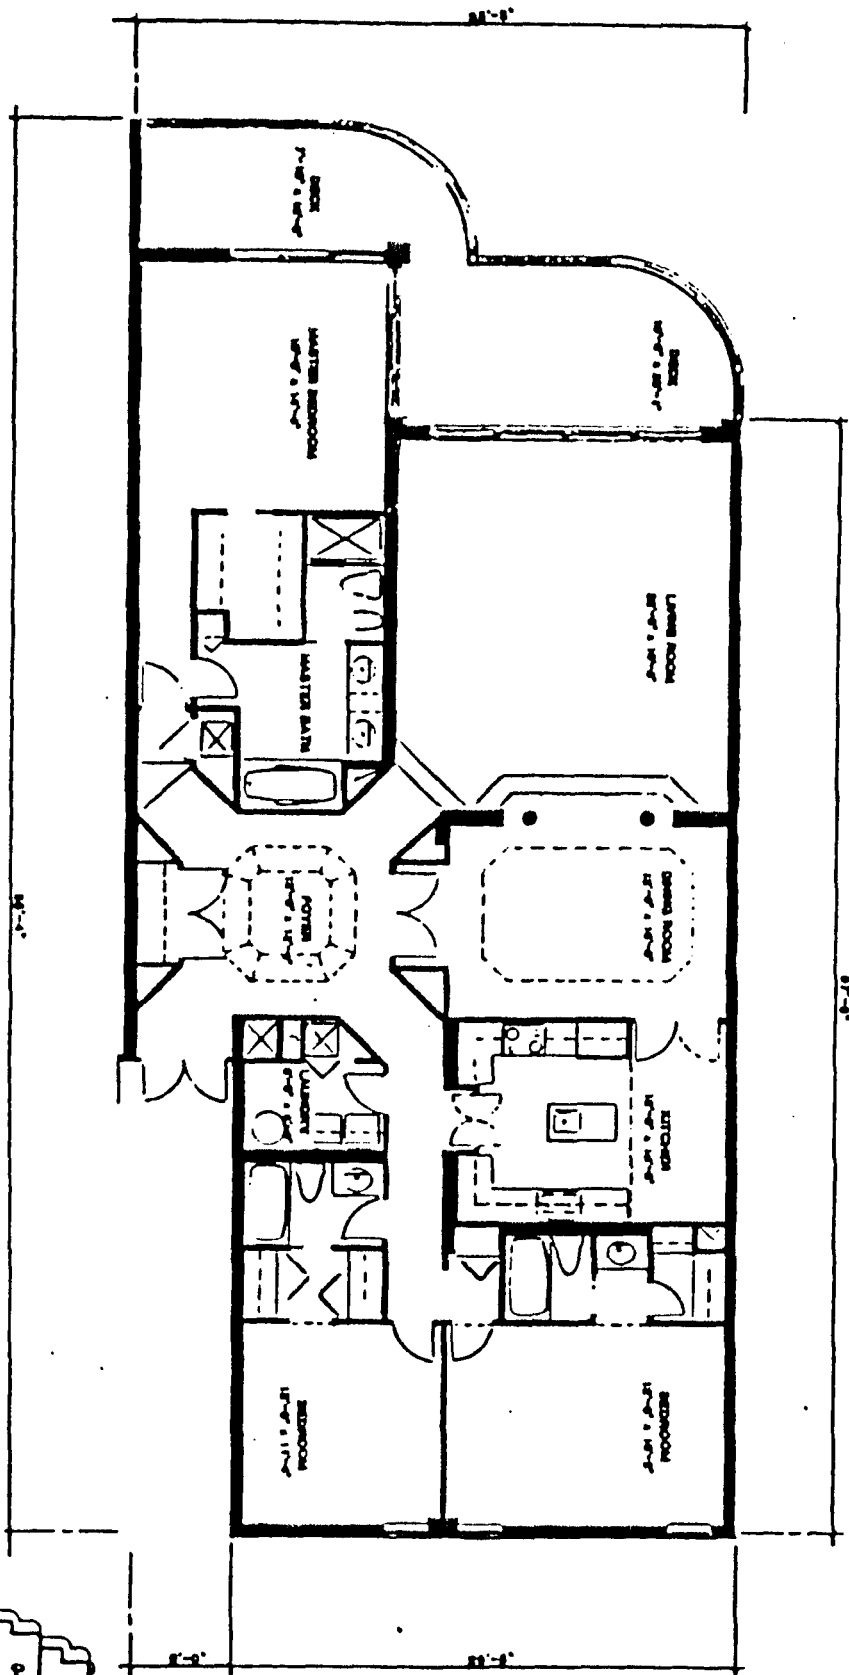


TYPICAL UNIT PLAN
 TOTAL SQUAD AREA

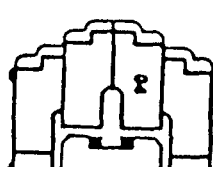


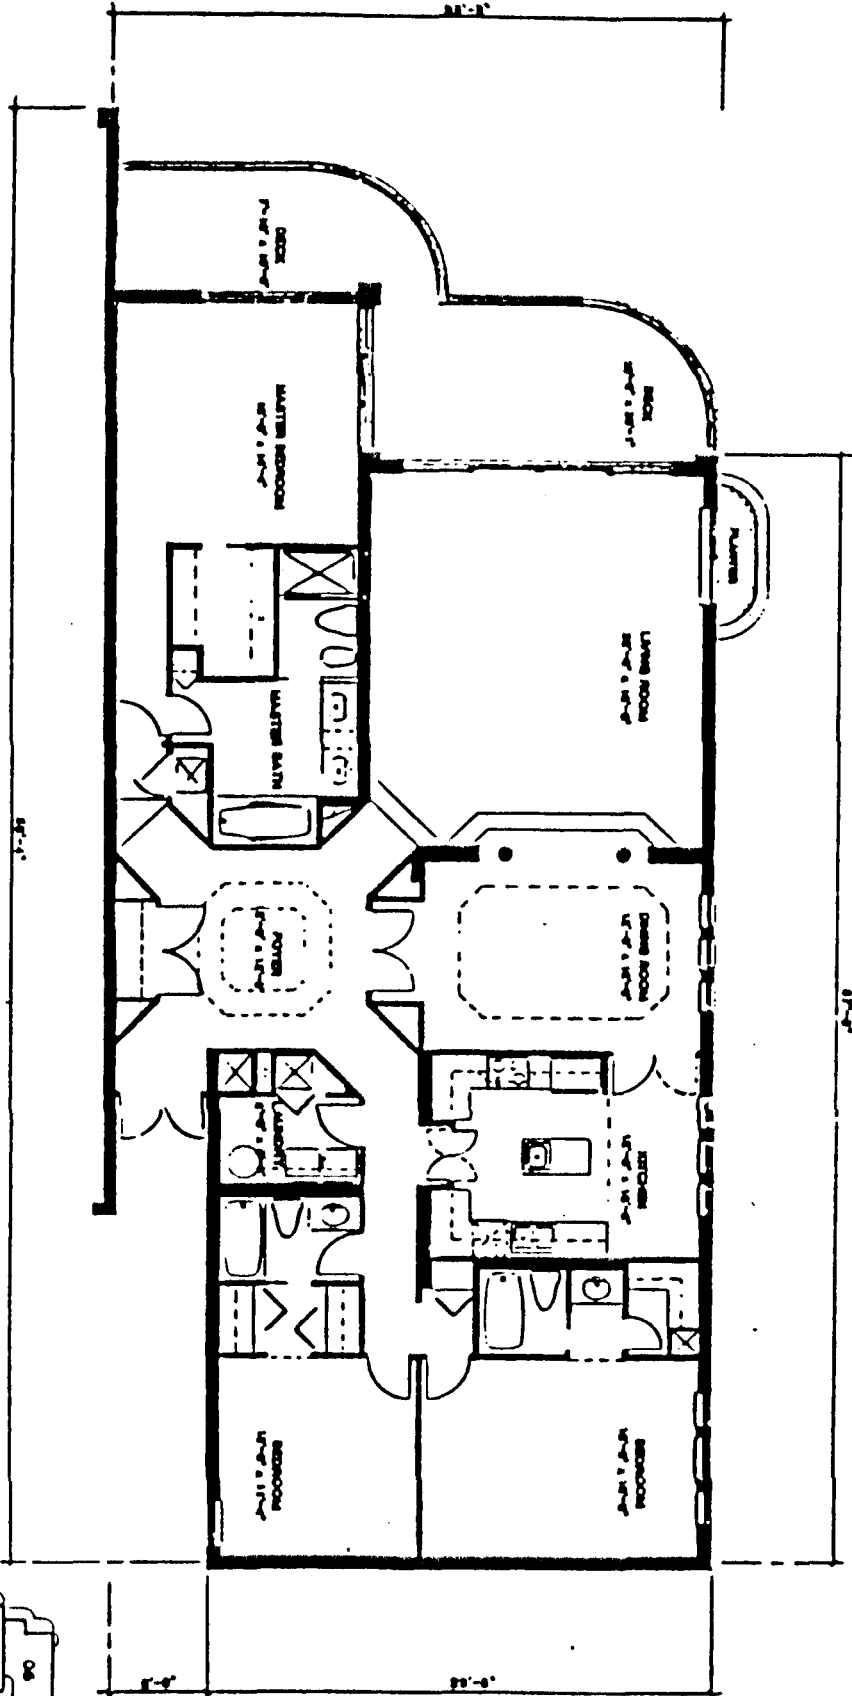

TYPICAL UNIT PLAN

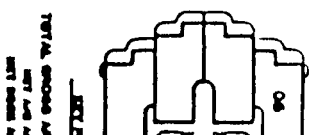


SCALE
TOTAL GROSS UNIT AREA
NET AREA

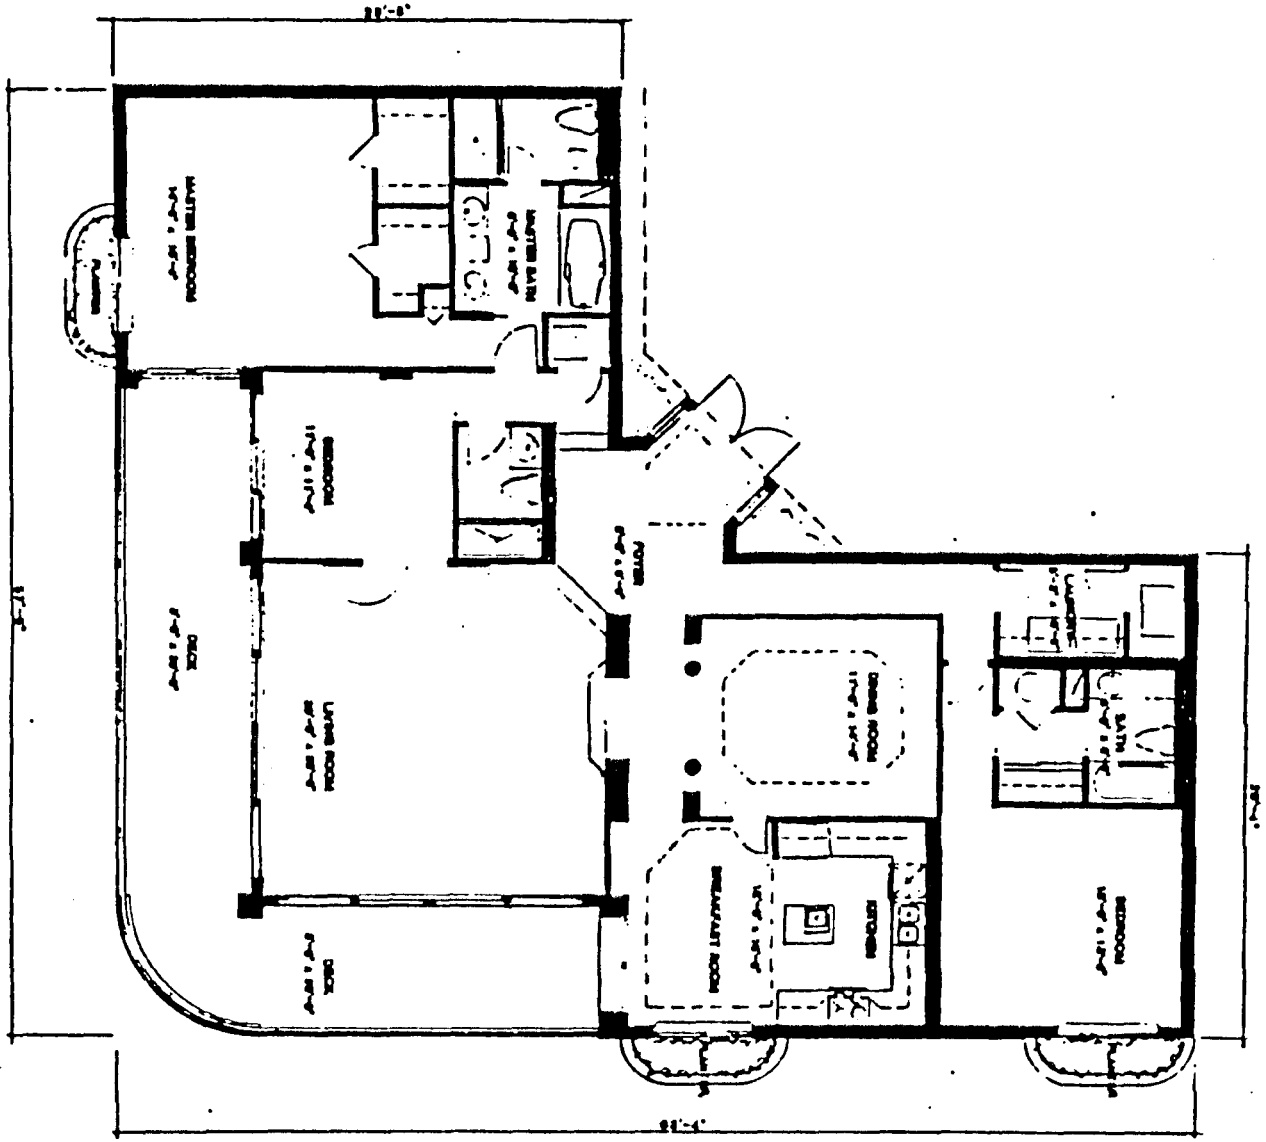


EASTERN UNIT PLAN



TOTAL ROOM AREA
1,177 SQ. FT.

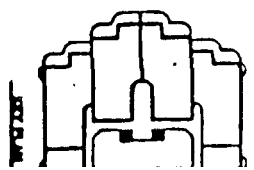


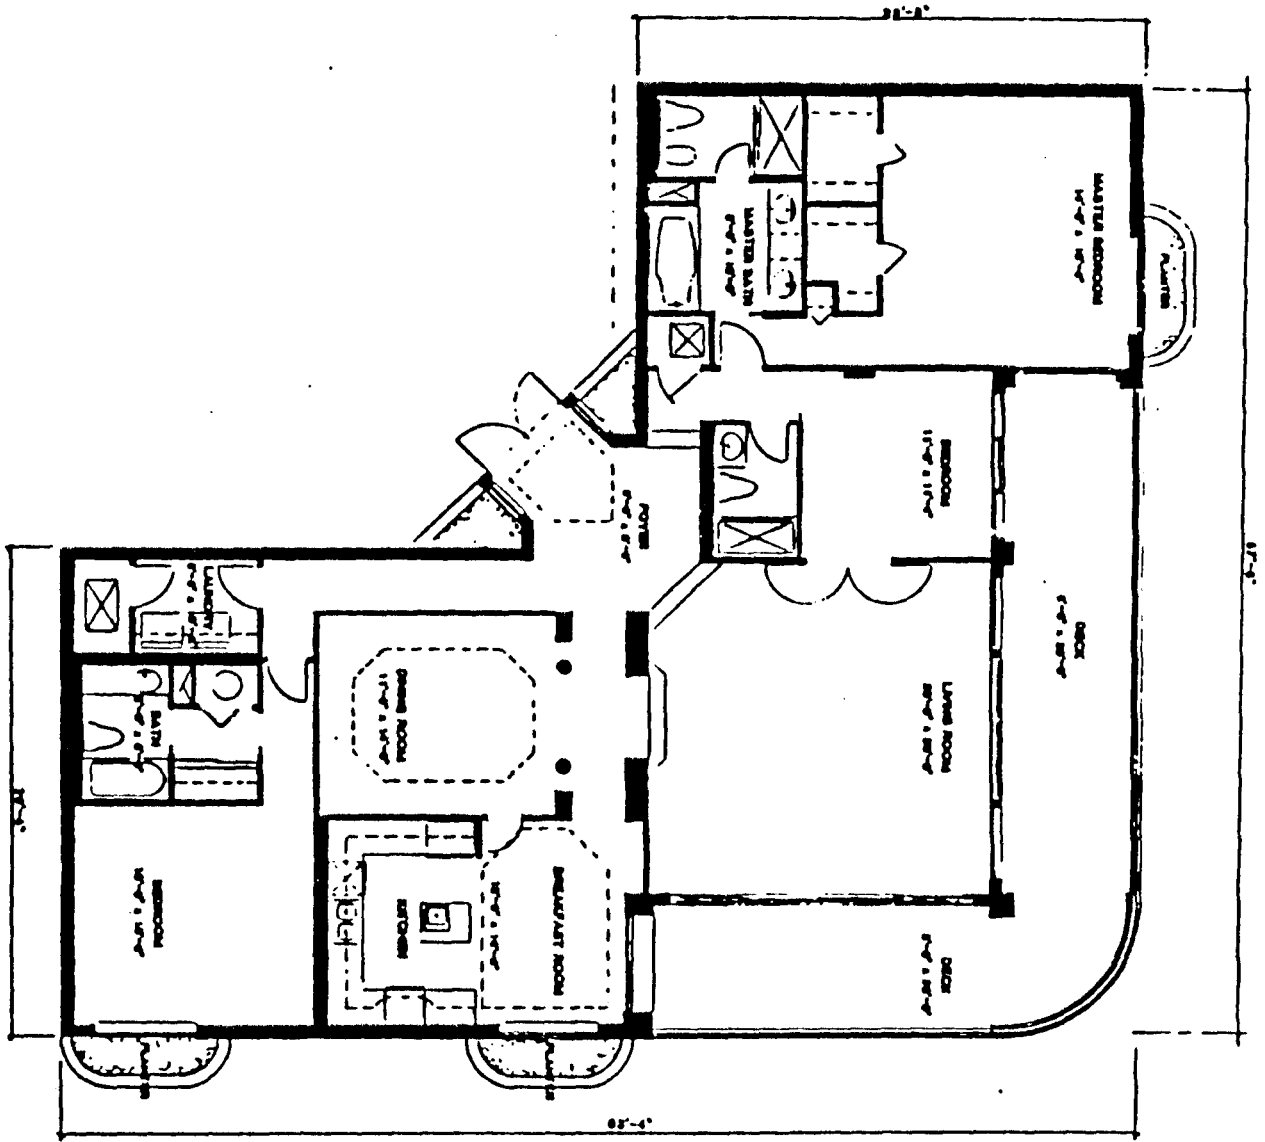


EASTERN UNIT PLAN



TOTAL GROSS /
NET AREA
SEE SHEET

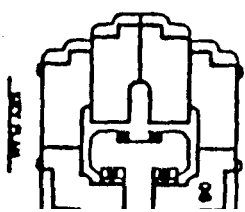


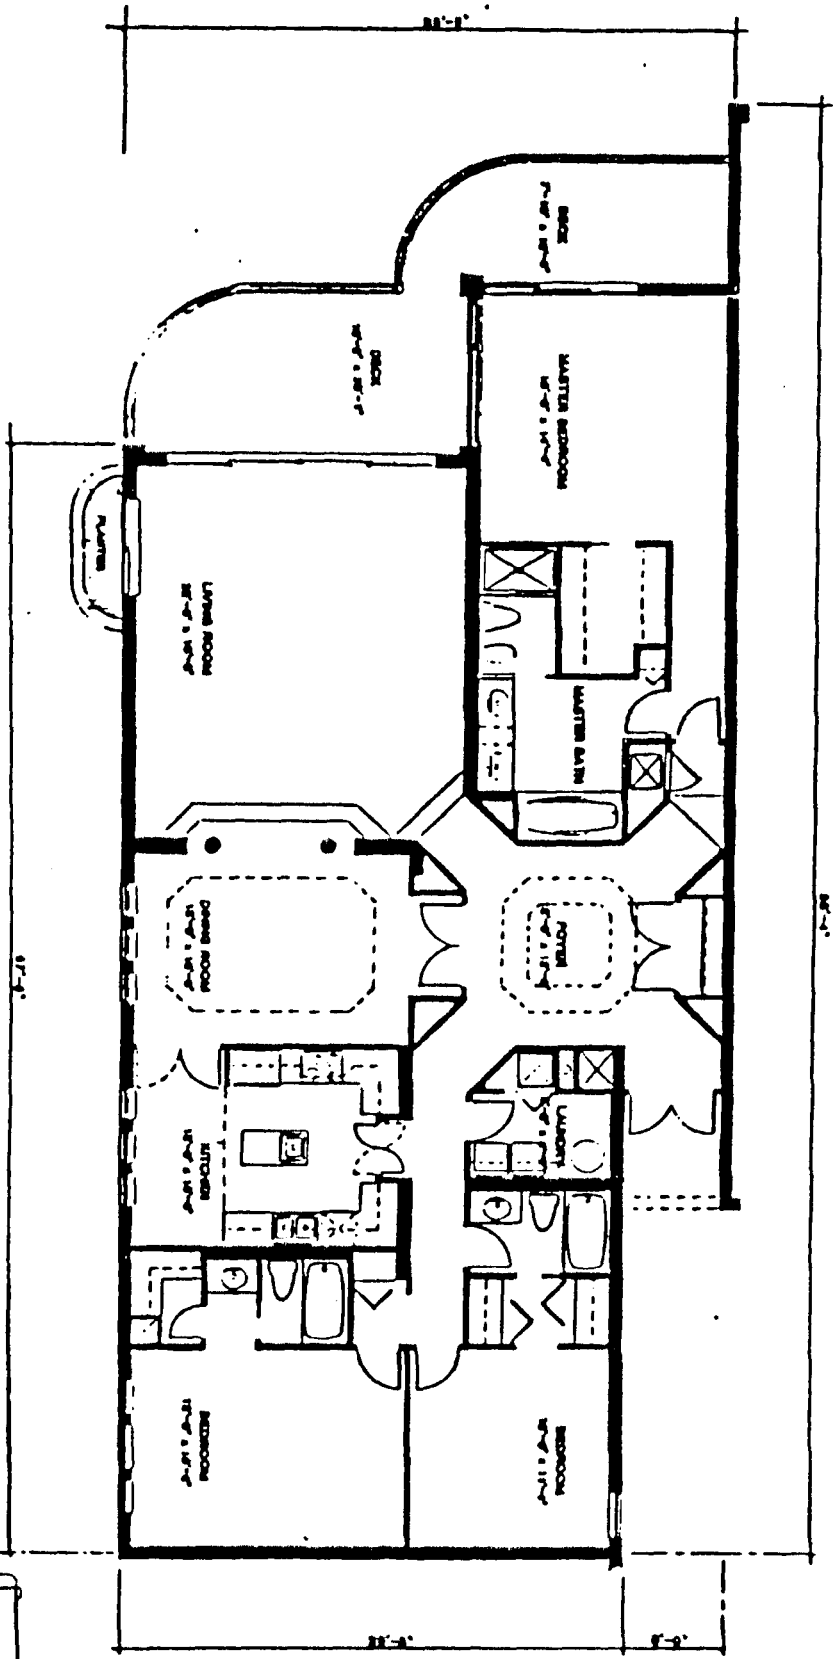


TYPICAL UNIT PLAN



SECTION
 TOTAL ROOMS ARE
 177 ARE 100
 1000 ROOMS ARE

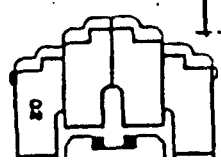


142'-0"

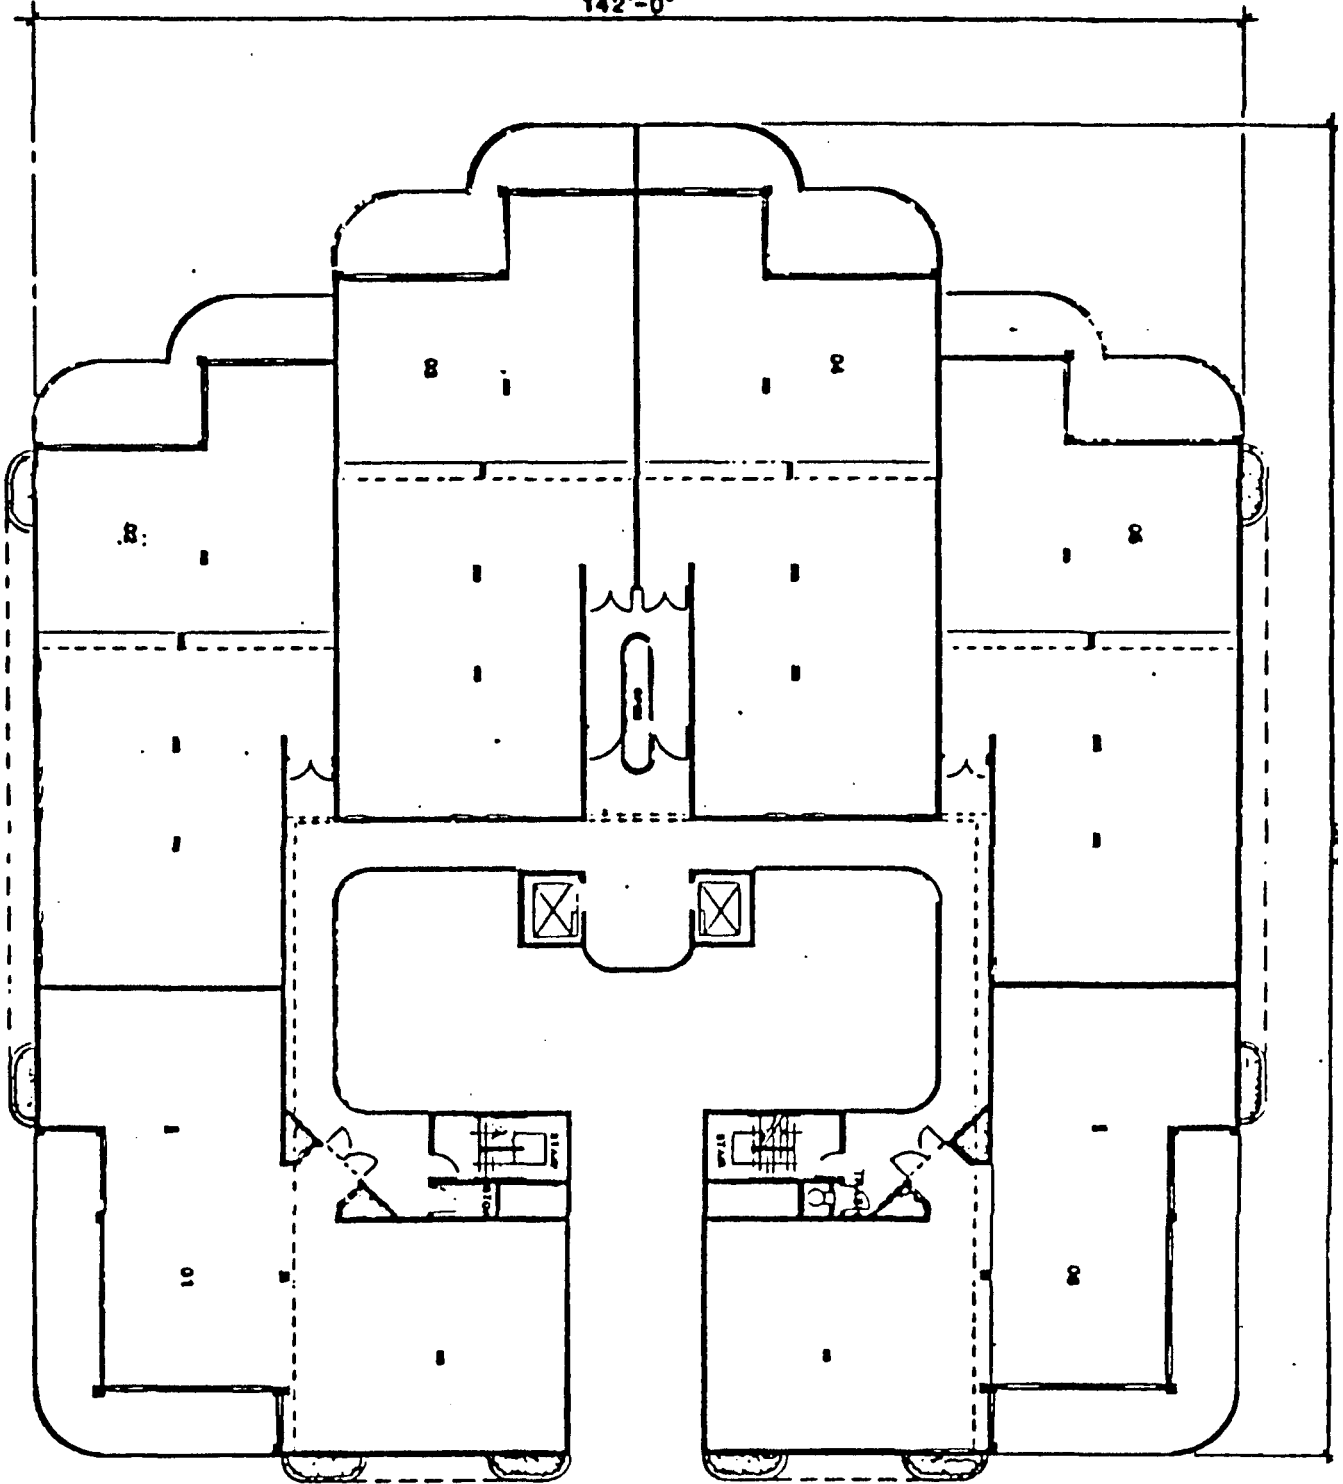


TYPICAL BUILDING PLAN

UNITS

AND THEORETICAL FLOOR AREA

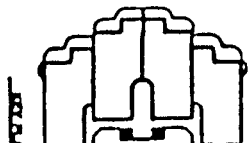

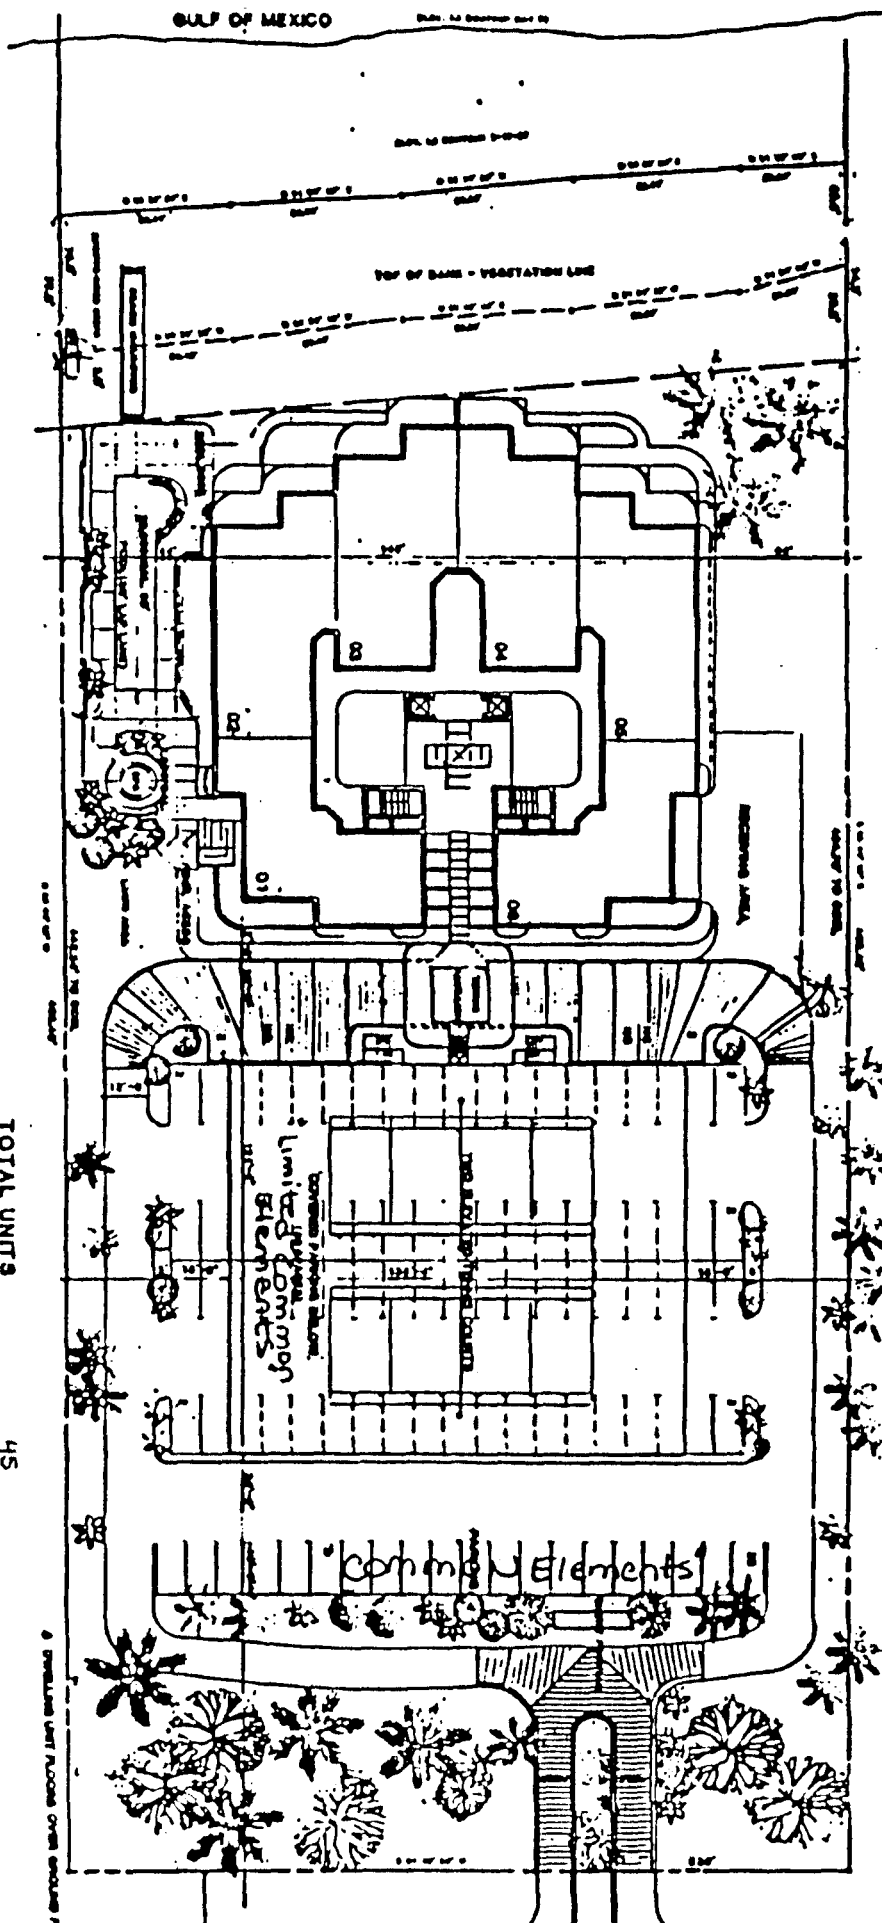


TOTAL UNITS 45
 LUXURY THREE BEDROOM UNITS 43
 PENTHOUSE UNITS 2
 TOTAL PARKING SPACES 100
 COVERED PARKING SPACES 60
 UNCOVERED PARKING SPACES 36
 HANDICAPPED PARKING SPACES 4

SITE PLAN




LES FALLS A CONDOMINIUM


Architect: **Les Falls**
 Engineer: **Les Falls**
 Date: **1/1/80**
 Scale: **1/8" = 1'-0"**
 Project: **LES FALLS**
 Drawing: **1/1/80**

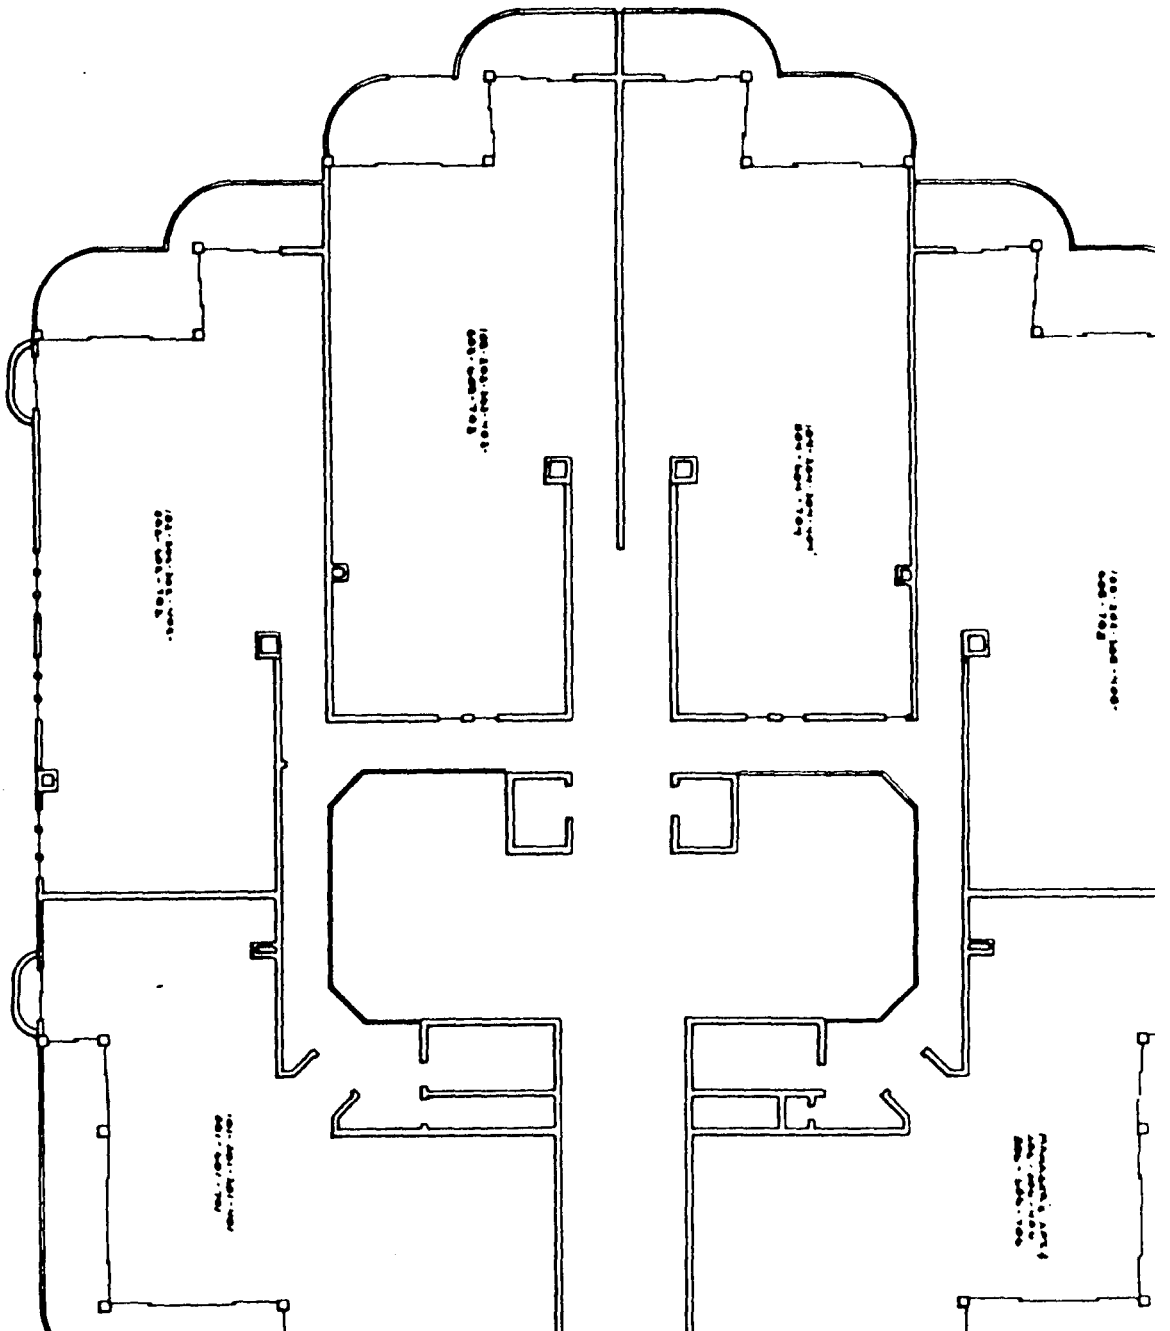


VILLA MARE' - UNIT "B"

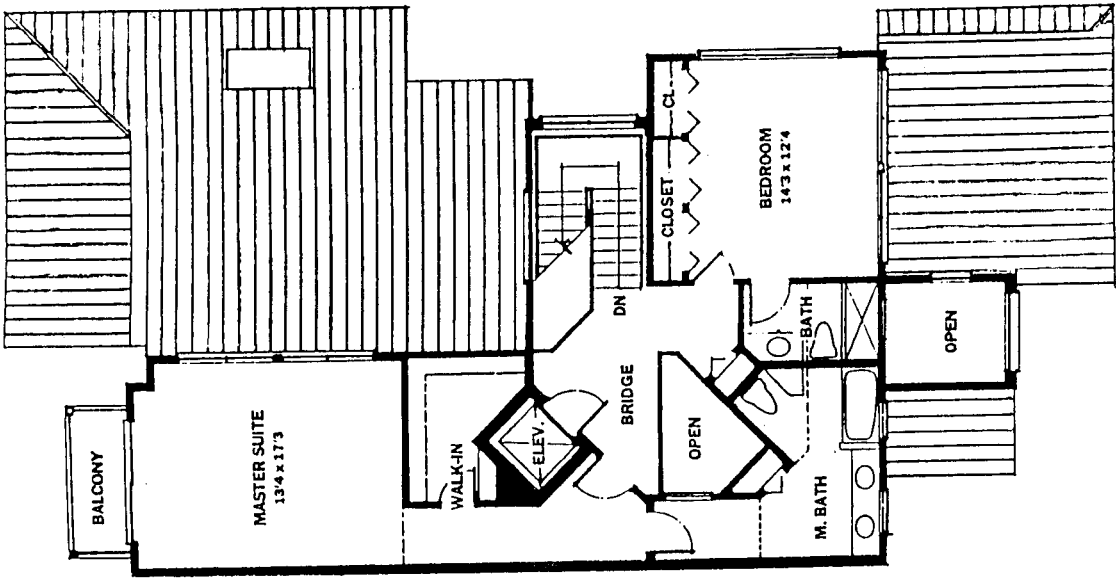

THIRD FLOOR

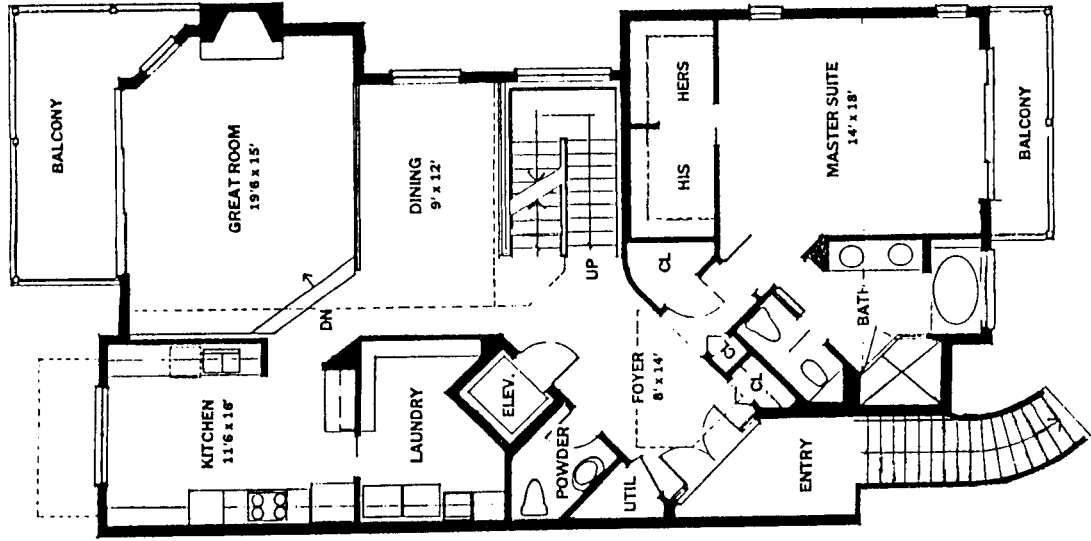


SECOND FLOOR

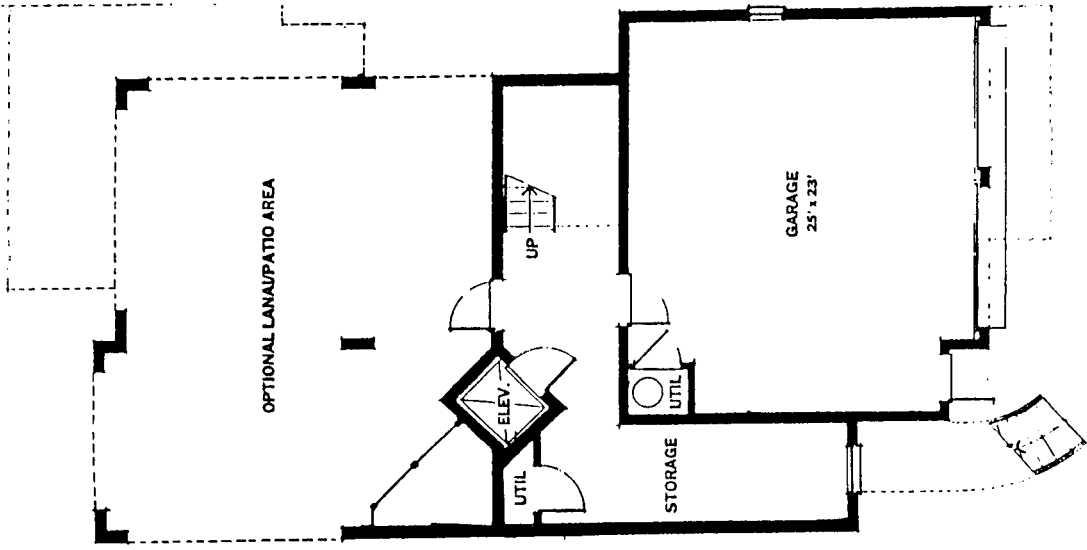

FIRST FLOOR

GULF OF MEXICO

PLAN: 44 (SEE SHEET 43)

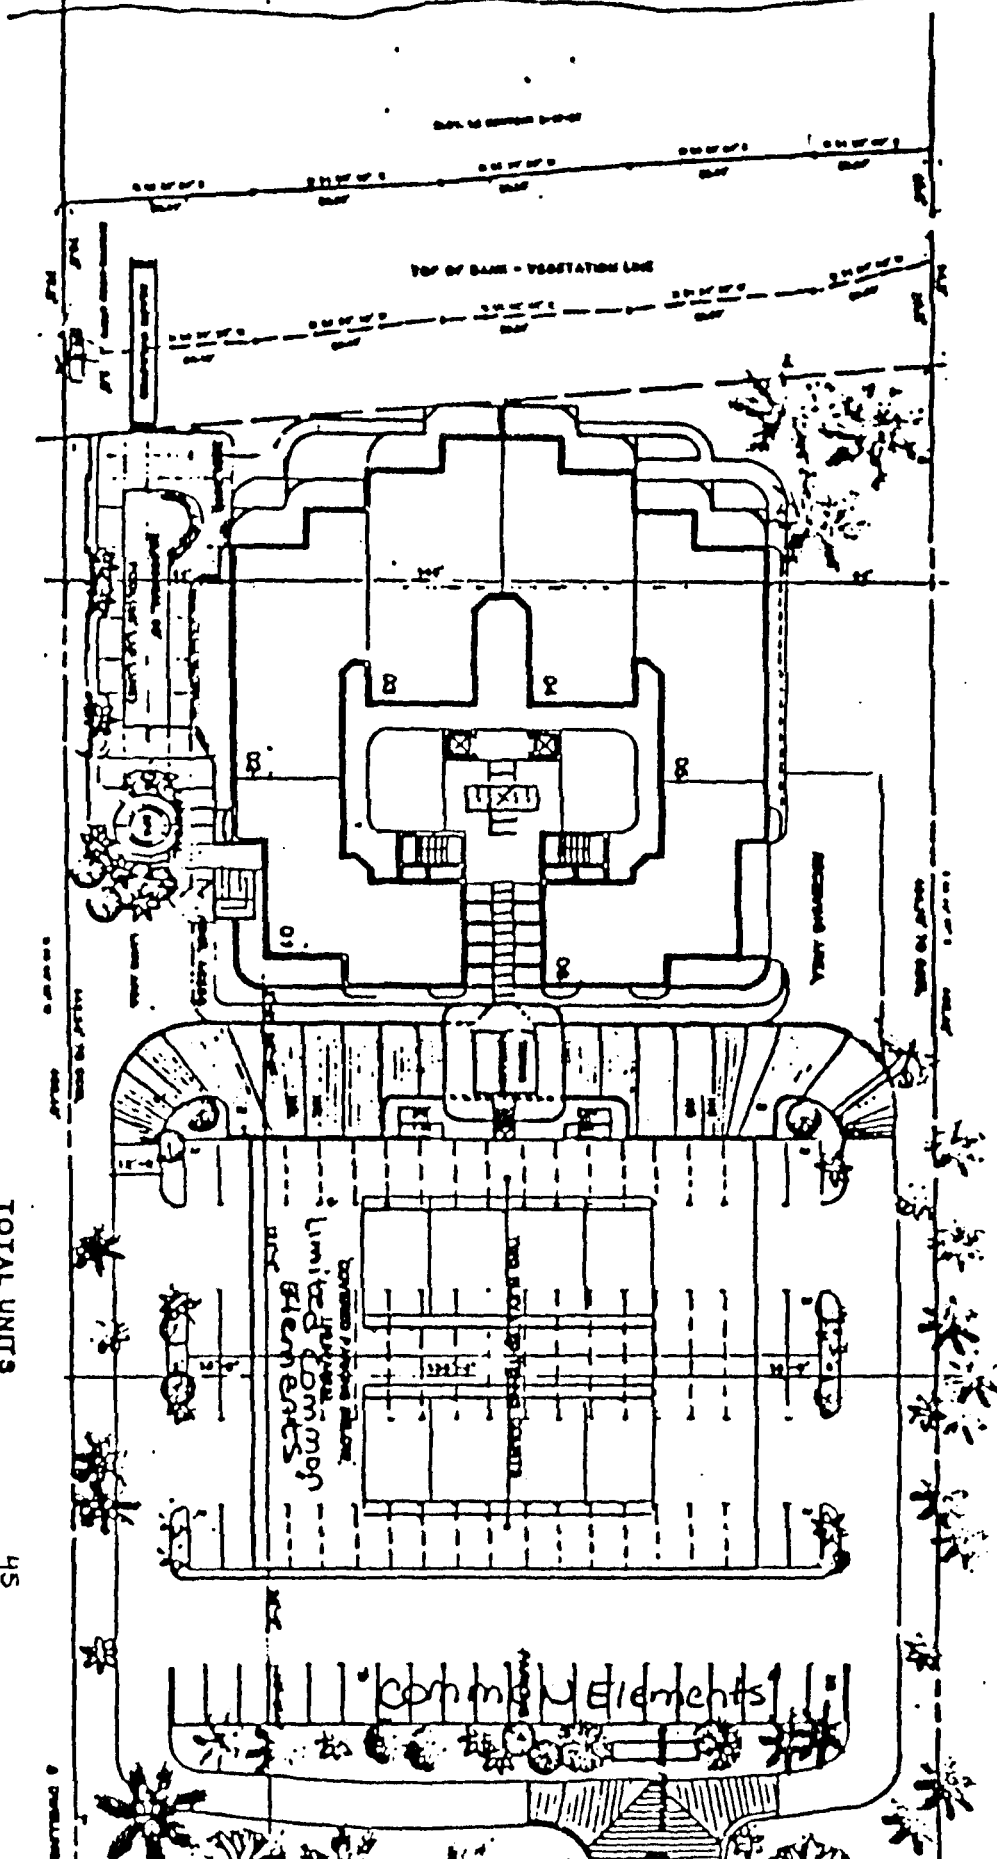


TOTAL UNITS 45
 LUXURY THREE BEDROOM UNITS 43
 PENTHOUSE UNITS 2
 TOTAL PARKING SPACES 100
 COVERED PARKING SPACES 60
 UNCOVERED PARKING SPACES 40
 HANDICAPPED PARKING SPACES 4

SITE PLAN
 1/2" = 1'

GULF OF MEXICO

PLAN TO SECTION 100-10

TOP OF BANK - VEGETATION LINE

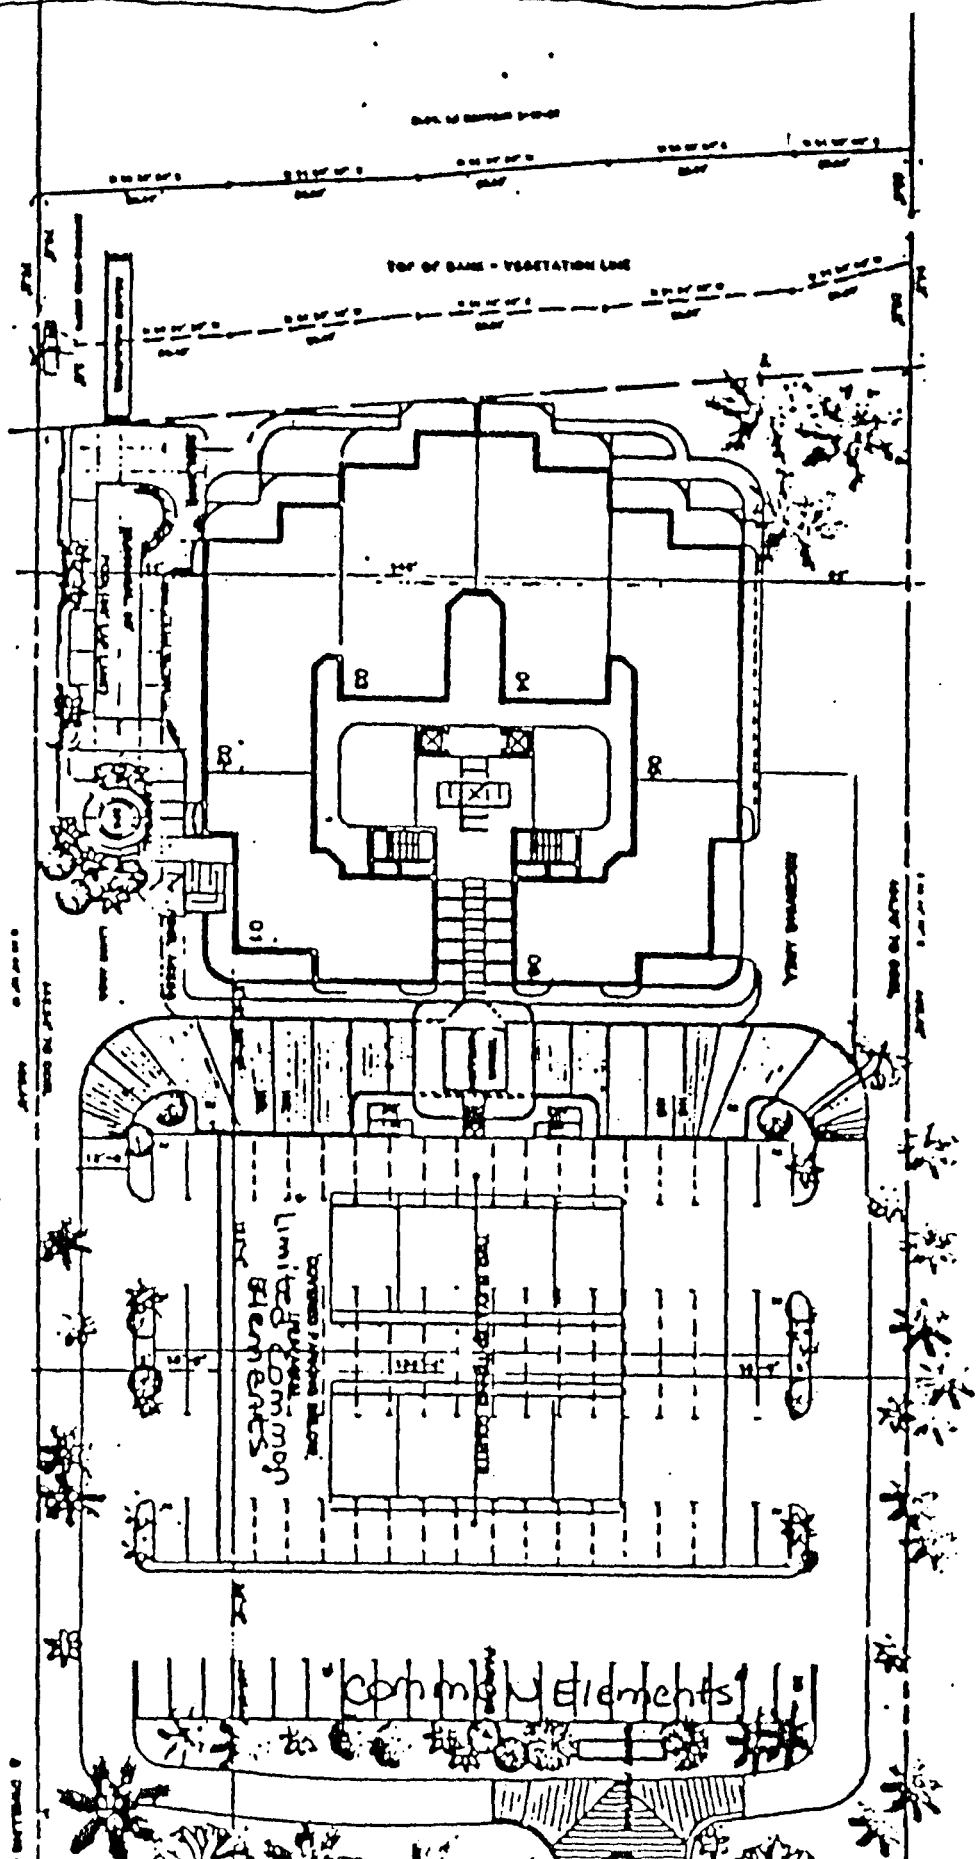

- TOTAL UNITS 45
- LUXURY THREE BEDROOM UNITS 43
- PENTHOUSE UNITS 2
- TOTAL PARKING SPACES 100
- COVERED PARKING SPACES 60
- UNCOVERED PARKING SPACES 40
- HANDICAPPED PARKING SPACES 4

SITE PLAN

SKETCH/AREA TABLE ADDENDUM

File No:

S U B J E C T	Borrower/Client TYPICAL "03", "04" UNIT - LES FALLS			
	Property Address 870 SOUTH COLLIER BOULEVARD			
	City MARCO ISLANT	County COLLIER	State FLORIDA	Zip Code 33937
	Lender			

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A R E A C A L C	AREA CALCULATIONS SUMMARY			LIVING AREA CALCULATIONS		
	Area	Name of Area	Size	Breakdown		Subtotals
		GLA1	LIVING AREA	2343	28.90	66.80
	2342.67	POR	OPEN BALCONY	1930.52	X.50	56.80
307.31			312.40	X.50	10.50	
			99.75			